ESSEX TOWNHOUSES FIRE DAMAGE REPAIR & EXTERIOR IMPROVEMENTS

1134 Quinnipiac Ave, New Haven, CT 06513

CWA PROJECT NO: 2401

HANH PROJECT NO: PM-24-IFB-944




FOR BIDDING **JULY 22 2024**

OWNER

ARCHITECT

203 776 0184



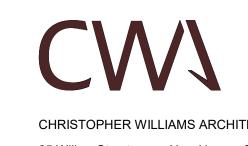

cwarchitectsllc.com

SHEET LIST							
NO.	SHEET NAME	SSUE 1 DATE					
A0	COVER SHEET	_					
G001	GENERAL ABBREVIATIONS & SYMBOLS						
G003	GENERAL INFORMATION & CODE NOTES						
C101	SITE PLAN						
H101	FIRST FLOOR ABATEMENT PLAN						
H102	SECOND FLOOR ABATEMENT PLAN						
H103	BUILDING E ABATEMENT PLAN						
AD101	UNIT 28-29 - BASEMENT & 1ST FL DEMOLITION PLANS						
AD102	UNIT 28-29 - 2ND FL & ROOF DEMOLITION PLANS						
A101	UNIT 28 & 29 BASEMENT & 1ST FLOOR PLANS						
A102	UNIT 28 & 29 2ND FLOOR & ROOF PLANS						
A103	BUILDING E - FIRST FLOOR PLAN						
A104	BUILDING E - RCP						
A201	UNIT 28-29 EXTERIOR ELEVATIONS						
A202	BUILDING E - EXTERIOR ELEVATIONS						
A301	UNIT 28 & 29 BLDG SECTIONS & DETAILS						
A302	BUILDING E - SECTION						
A501	DECK WALL SECTIONS						
A502	DECK DETAILS						
A503	SIDING & ROOF DETAILS						
A504	INTERIOR DETAILS						
MEP 101	UNIT 28 & 29 BASEMENT & 1ST FL PLANS						

DESCRIPTION OF WORK

MEP 102 UNIT 28 & 29 2ND FLOOR MEP PLAN

- 1. REMOVE AND REPLACE ALL DAMAGED EXTERIOR SIDING ON FIRE DAMAGED UNITS


APPLICABLE CODES

- 1. NFPA 72. NATIONAL FIRE ALARM AND SIGNALING CODE 2019 EDITION 2. NFPA 720 STANDARD FOR THE INSTALLATION OF CARBON MONOXIDE DETECTION
- AND WARNING EQUIPMENT, 2015 EDITION.
- 3. NFPA 70. THE NATIONAL ELECTRICAL CODE 2020 EDITION.
 4. INTERNATIONAL RESIDENTIAL CODE 2021 EDITION.
- 5. INTERNATIONAL FIRE CODE 2021 EDITION.
- 6. CONNECTICUT STATE BUILDING CODE 2022 EDITION.
 7. CONNECTICUT STATE FIRE SAFETY CODE 2022 EDITION.
- 8. CONNECTICUT STATE FIRE PREVENTION CODE 2022 EDITION.

LOCATION MAP



Autodesk Docs://2401 - Essex Townhouses Fire Damage Repair/2401 - Essex Townhouses Fire Damage Repair R24.rvt 8/1/2024 12:16:01

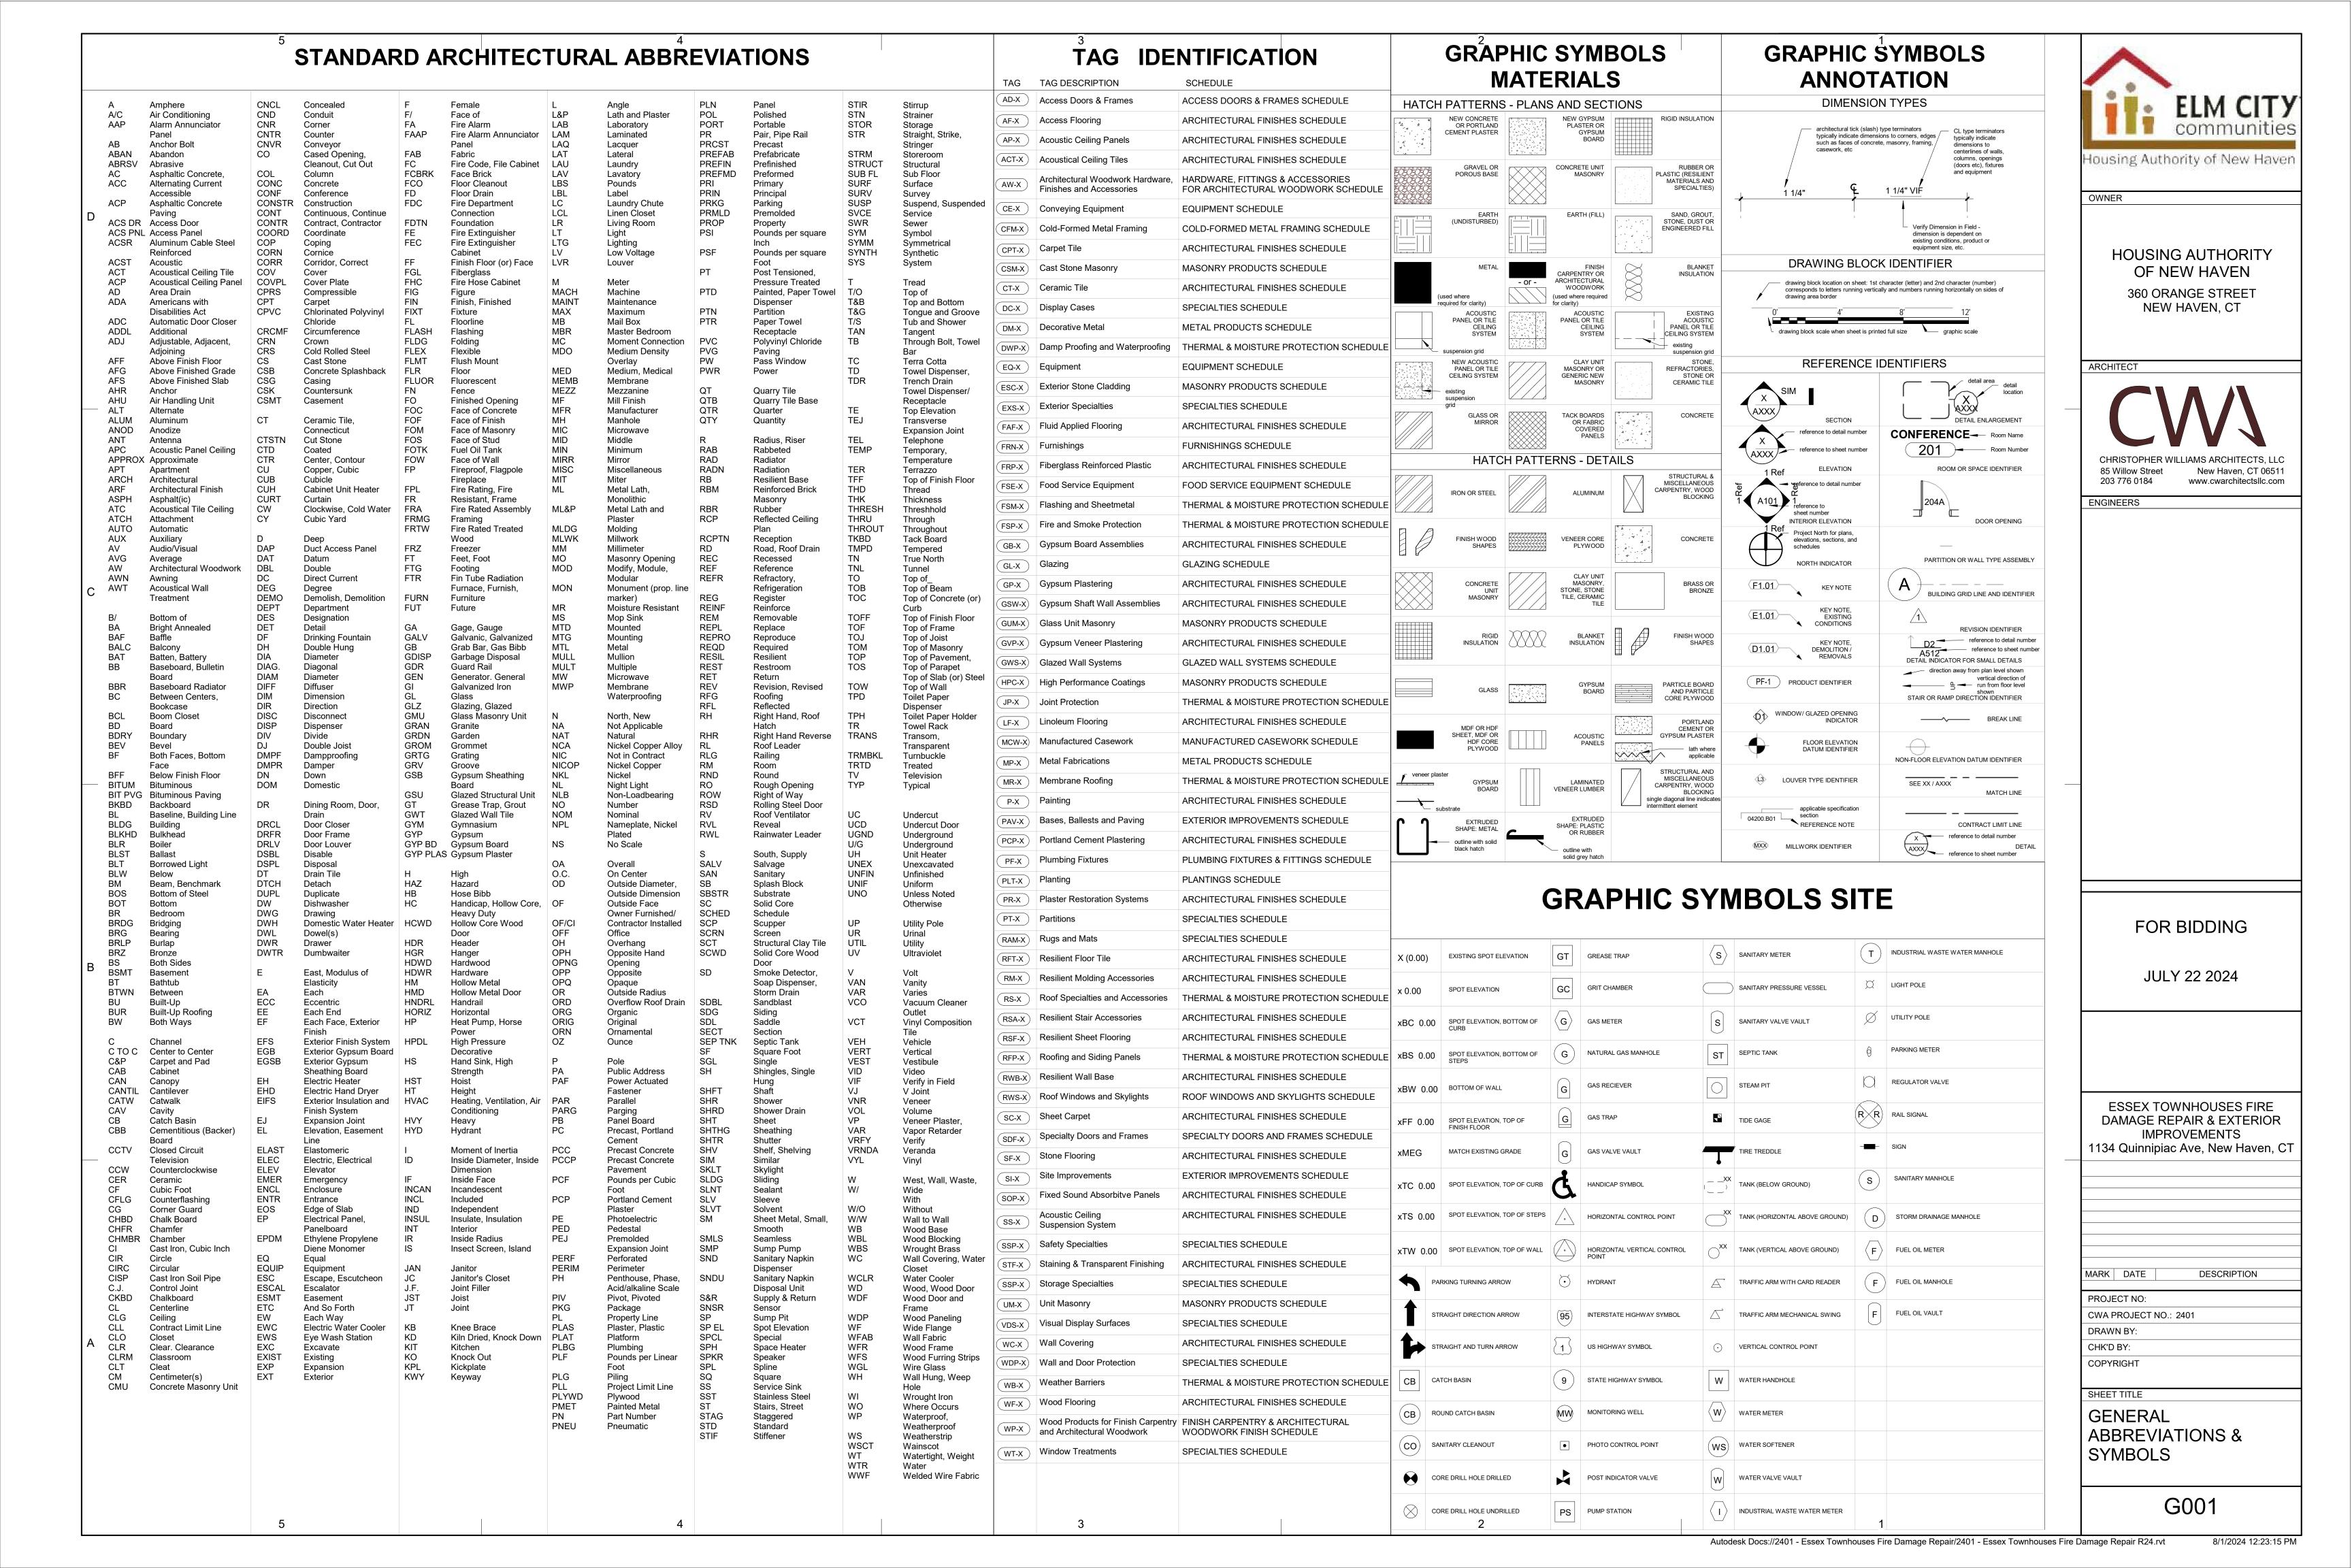

CORRELATION OF CONTRACT DOCUMENTS

- THE CONTRACT DOCUMENTS ARE COMPLEMENTARY, AND WHAT IS CALLED FOR BY ANY ONE SHALL BE AS BINDING AS IF CALLED FOR BY ALL. WHERE DISCREPANCIES OR CONFLICT OCCUR IN THE CONTRACT DOCUMENTS THE FOLLOWING ORDER OF PRECEDENCE SHALL BE UTILIZED:
 - AMENDMENTS AND ADDENDA SHALL TAKE PRECEDENCE OVER PREVIOUSLY ISSUED CONTRACT DOCUMENTS
 - SPECIFICATIONS SHALL TAKE PRECEDENCE OVER THE PLANS STATED DIMENSIONS SHALL TAKE PRECEDENCE OVER SCALED DIMENSIONS
 - LARGE-SCALE DETAIL DRAWINGS SHALL TAKE PRECEDENCE OVER SMALL-SCALE DRAWINGS
 - THE SCHEDULES CONTAINED IN THE CONTRACT DOCUMENTS SHALL TAKE PRECEDENCE OVER OTHER DATA ON THE PLANS

EXISTING CONDITIONS

- EXISTING DIMENSIONS AND CONDITIONS SHOWN IN THE CONTRACT DOCUMENTS ARE ASSUMED BY THE ARCHITECT TO BE SUBSTANTIALLY ACCURATE BASED ON AVAILABLE INFORMATION.
- THE CONTRACTOR SHALL, PRIOR TO THE START OF CONSTRUCTION, REVIEW DOCUMENTS, VERIFY ALL EXISTING CONDITIONS AND NOTIFY THE ARCHITECT OF ANY DEVIATIONS OR CONFLICTS WITH THE CONTRACT DOCUMENTS.
- EXISTING CONDITIONS SHOWN ON PLANS ARE BASED ON RECORD DOCUMENTS AND LIMITED FIELD OBSERVATIONS. VERIFY FIELD CONDITIONS AND CONFIRM THAT WORK IS BIDDABLE AS SHOWN. REPORT ANY CONFLICTS, OMISSIONS OR DISCREPANCIES TO THE ARCHITECTS FOR CLARIFICATION PRIOR TO PERFORMING ANY WORK IN QUESTION. REFER TO THE PROJECT MANUAL REGARDING THE REQUEST FOR INFORMATION (RFI) PROCESS.

USE OF SITE

- THE CONTRACTOR SHALL CONFINE OPERATIONS AT THE SITE TO AREAS PERMITTED BY LAW, ORDINANCES, PERMITS AND THE CONTRACT DOCUMENTS AND
- SHALL NOT UNREASONABLY ENCUMBER THE SITE WITH MATERIALS OR EQUIPMENT. THE CONSTRUCTION MANAGER SHALL BE RESPONSIBLE FOR PROTECTING EXISTING FURNISHINGS AND PERSONAL PROPERTY OF OCCUPANTS FROM START
- TO FINISH OF CONSTRUCTION ACTIVITIES IN ALL LOCATIONS THROUGHOUT THE WORK AREA.

LAYOUT AND DIMENSION CONTROLS

- THE DRAWINGS ARE NOT TO BE SCALED, THE GENERAL CONTRACTOR IS TO REFER TO THE DIMENSIONS INDICATED OR THE ACTUAL SIZES OF CONSTRUCTION ITEMS. WHERE NO DIMENSION OR METHOD OF DETERMINING A LOCATION IS GIVEN, VERIFY CORRECT LOCATION WITH THE ARCHITECT PRIOR TO INSTALLATION.
- DRAWINGS AND REFERENCED DETAILS HAVE BEEN DIMENSIONED IN ORDER TO ESTABLISH THE CONTROL AND GUIDELINES FOR FIELD LAYOUT. WHERE A DISCREPANCY EXISTS BETWEEN THE DRAWING AND THE DETAIL THE CONTRACTOR SHALL NOTIFY THE ARCHITECT FOR CLARIFICATION PRIOR TO
- VERIFY SIZE, LOCATION AND CHARACTERISTICS OF ALL EQUIPMENT TO BE FURNISHED WITH MANUFACTURERS OR SUPPLIERS BEFORE BEGINNING CONSTRUCTION.
- VERIFY SIZE AND LOCATION OF ALL OPENINGS FOR PLUMBING, MECHANICAL AND ELECTRICAL EQUIPMENT AND RELATED WORK WITH CONTRACTORS INVOLVED AND EQUIPMENT TO BE INSTALLED. FOR CONSTRUCTION DETAILS NOT SHOWN USE THE MANUFACTURER'S STANDARD DETAILS OR APPROVED SHOP DRAWINGS/DATA SHEETS IN ACCORDANCE WITH THE PROJECT SPECIFICATIONS.
- VERIFY ALL ELEVATIONS AND DIMENSIONS OF STRUCTURAL ELEMENTS WITH ARCHITECTURAL SHEETS, IN CASE OF CONFLICT NOTIFY THE ARCHITECT. THE CONTRACTOR SHALL VERIFY ALL DIMENSIONS AND BE RESPONSIBLE FOR THEM. ALL DIMENSIONAL DISCREPANCIES SHALL BE BROUGHT TO THE ATTENTION OF THE ARCHITECT.
- INTERIOR DIMENSIONS ARE TO FINISH FACES, EDGES OR CENTERLINES UNLESS OTHERWISE NOTED
- THE CONTRACTOR SHALL NOTIFY THE ARCHITECT OF ANY VARIATION IN FIELD LAYOUT WHICH WILL NOT ACCOMMODATE THESE REQUIREMENTS PRIOR TO ANY FIELD INSTALLATION.

ARCHITECTURAL SHEETS - DETAILS AND FINISHES

- INTERIOR AND EXTERIOR FINISHES AND DETAILS ARE KEYED TO THE DRAWINGS AT TYPICAL LOCATIONS. THE FINISHES APPLY TO ALL LOCATIONS THAT ARE NOT KEYED IN AND ARE OF THE SAME FINISH AND SCOPE OF WORK. THE CONTRACTOR AND SUBCONTRACTORS ARE RESPONSIBLE TO COORDINATE THE LOCATION OF FINISH MATERIALS AND INSTALL THE WORK INDICATED. IF DISCREPANCIES EXIST OR QUALIFICATION IS REQUIRED THE CONTRACTOR IS TO NOTIFY THE ARCHITECT TO OBTAIN CLARIFICATION.
- DETAILS NOTED AS TYPICAL OR SIMILAR, OR WHICH CAN BE REASONABLY CONSTRUED AS TYPICAL OR SIMILAR, SHALL APPLY TO ALL SIMILAR CONDITIONS UNLESS OTHERWISE NOTED, REGARDLESS IF SPECIFICALLY NOTED OR NOT. SIMILAR ITEMS GRAPHICALLY REPRESENTED IN DIFFERENT LOCATIONS, WITH OR WITHOUT SPECIFIC VERBIAGE, SHALL BE CONSIDERED TYPICAL OR SIMILAR AND SHALL BE INCLUDED IN THE SCOPE OF WORK.
- PATCH ALL EXISTING FLOORS. WALLS AND CEILINGS WHERE DISTURBED BY REMOVAL AND/OR MODIFICATIONS. CREATE SEAMLESS SURFACE WITH MATCHING FINISHES APPLIED.

PLUMBING, MECHANICAL AND ELECTRICAL SYSTEMS COORDINATION

ALL WALLS EXCEPT BATHROOM: EGGSHELL FINISH.

STAIR TREADS, RISERS & STRINGER: GLOSS

ALLOW SURFACES TO DRY. CLEAN OFF ANY DUST/DEBRIS.

DOOR FRAMES, CASING, WINDOW SILLS/STOOLS: SEMI GLOSS.

BATH ROOM WALLS: SEMI GLOSS

CEILINGS: FLAT

VACUUM THE SURFACES CLEAN.

APPLICATIONS.

VACUUM THE SURFACES.

GENERAL CONTRACTOR AND THE SUBCONTRACTORS ARE RESPONSIBLE FOR AND SHALL COORDINATE ALL WORK AS IT RELATES TO OTHER TRADES.

2. FINISH STAIR HANDRAIL: CLEAN & LIGHTLY SAND. APPLY 2 COATS OF SATIN FINISH POLYURETHANE AFTER RE-INSTALLATION TO WALL.

3. STAIR TREADS, RISERS & STRINGERS: CLEAN, SAND & PREP. PROVIDE 2 COATS OF FLOORING PAINT. MATCH EXISTING COLOR.

CLEAN FIRE /SMOKE DAMAGED SURFACES TO REMAIN WITH FIBERLOCK RECON HEAVY DUTY CLEANER. APPLY FIBERLOCK RECON EXTEREME DUTY ODOR COUNTERACTANT IN A MIN. OF ONE APPLICATION.

ALL SUBCONTRACTORS ARE TO COORDINATE INSTALLATION OF MECHANICAL, PLUMBING, AND ELECTRICAL WORK WITH THE HEIGHTS INDICATED ON THE ARCHITECTURAL SHEETS. SUBCONTRACTORS ARE RESPONSIBLE TO NOTIFY THE GENERAL CONTRACTOR OF ANY DISCREPANCIES OR CONFLICTS. THE GENERAL CONTRACTOR SHALL INFORM THE ARCHITECT OF ANY DISCREPANCIES.

PROVIDE UL-LISTED FIRE/SMOKE STOP ASSEMBLY SYSTEM AT ALL PENETRATIONS THROUGH ALL WALL AND FLOOR SYSTEMS. FIRESTOPPING SHALL BE

DESIGNED TO RESIST THE SPREAD OF FIRE FOR A TIME PERIOD NOT LESS THAN THE REQUIRED FIRE RESISTANT RATING OF THE PENETRATED ASSEMBLY. AND FOR NOT LESS THAN 2 HOURS REGARDLESS OF THE ACTUAL ASSEMBLY RATING. ALL TRADES SHALL PROVIDE THE SAME SYSTEM BY THE SAME MANUFACTURER FOR EACH ASSEMBLY.

INTERIOR FINISHES NOTES

WOOD TREATMENT FOR FUNGAL GROWTH

1. PAINT ALL INTERIOR WALLS & CEILINGS, NEW & EXISTING WITH SPECIFIED PAINT. COLORS SHALL BE SELECTED BY THE ARCHITECT. THREE PAINTS SHALL BE SELECTED WITH THE FOLLOWING GLOSS LEVELS:

APPLY FIBERLOCK ADVANCED PEROXIDE CLEANER, FOLLOWING THE MANUFACTURER'S INSTRUCTIONS, INCLUDING FOR THE WAITING PERIOD BETWEEN APPLICATIONS. APPLY A MINIMUM OF 2

SMOKE ODOR SEALER NOTES

THE ABOVE APPLIES TO ALL SMOKE OR FIRE DAMAGED WOOD SURFACES THAT ARE NOT SUFFICIUENTLY CHARRED TO REQUIRE REMOVAL. SEE DEMO & ROOF PLANS FOR EXTENT OF REMOVALS.

ALLOW WOOD TO DRY TO THE POINT WHERE A MOISTURE TEST ON THE CLEANED AREA OF READS THE SAME AS A MOISTURE TEST ON UNCOMPROMISED SURFACES IN THE SAME UNIT.

APPLY FIBERLOCK ULTRA RECON (# 3092-WHITE) SMOKE ODOR SEALANT GENEROUSLY BY BRUSH OR AIRLESS SPRAY TO ENSURE SURFACE IS PROPERLY SEALED. APPLY IN 2 COATS.

SCRUB BRUSH THE WOOD SURFACE CLEAN WITH A CLEANING PRODUCT. TSP, SIMPLE GREEN, FORMULA 409 OR SIMILAR. REMOVE ALL DIRT, SAWDUST & DEBRIS.

ALTERATION & DEMOLITION NOTES

- THE FOLLOWING NOTES APPLY TO ALL WORK AND DRAWINGS IN PROJECT SCOPE.
- EXERCISE CARE NOT TO DAMAGE EXISTING BUILDING ELEMENTS AND FINISHES TO REMAIN DURING CONSTRUCTION. IN THE EVENT THAT DAMAGE DOES OCCUR PATCH/REPAIR OR REPLACE DAMAGED ELEMENTS OR FINISHES IN KIND AND/OR TO MATCH EXISTING.
- ALL PIPING PENETRATIONS THROUGH EXISTING WALLS, CEILINGS AND FLOORS SHALL BE DRILLED AND SLEEVED. PENETRATIONS THOUGH INTERIOR WALLS SHALL BE FIRE SAFE WITH DESIGNATED UL SYSTEMS; SEE FIRESTOPPING IN GENERAL NOTES (THIS PAGE). PENETRATIONS THROUGH EXTERIOR WALLS SHALL
- THE PREMISES SHALL BE KEPT FREE FROM ACCUMULATION OF TRASH AND CONSTRUCTION DEBRIS AT ALL TIMES. DISPOSE OF EXCESS TRASH AND DEBRIS OFF-SITE IN A SAFE, ACCEPTABLE MANNER.
- FIELD VERIFY EXISTING CONDITIONS AND DIMENSIONS PRIOR TO COMMENCEMENT OF WORK. REPORT ANY DISCREPANCIES TO ARCHITECT PRIOR TO PROCEEDING.
- DIMENSIONS INDICATED ON DRAWINGS ARE TO BE USED FOR CONSTRUCTION, DO NOT SCALE DRAWINGS.
- PARTITION DIMENSIONS SHOWN ON FLOOR PLANS ARE TO FINISH FACE OF WALL.
- FIELD VERIFY ALL (±) AND (V.I.F) DIMENSIONS PRIOR TO START OF WORK. REPORT ANY DISCREPANCIES THAT WILL AFFECT NEW WORK TO ARCHITECT PRIOR
- DOOR FRAMES AT CORNERS OF ROOMS ADJACENT TO INTERSECTING WALLS SHALL BE INSTALLED WITH THE DOOR OPENING 4" FROM INSIDE CORNER OF WALLS UNLESS OTHERWISE INDICATED. MEASUREMENT SHALL BE FROM FINISH FACE OF WALL.
- 10. IF INFORMATION ON DRAWINGS IS UNCLEAR OR ADDITIONAL DIMENSIONS ARE REQUIRED NOTIFY ARCHITECT PRIOR TO PROCEEDING WITH WORK.
- THE TERM "TYPICAL" OR "TYP" INDICATED ON THE CONTRACT DOCUMENTS SHALL MEAN THAT THE CONDITION IS THE SAME OR SIMILAR THROUGHOUT UNLESS OTHERWISE INDICATED.
- ALL EXISTING FINISHES AND BUILDING ELEMENTS AFFECTED BY DEMOLITION AND NEW WORK SHALL BE PATCHED TO MATCH EXISTING, WHETHER OR NOT
- ALL WORK SHALL BE PERFORMED IN A UNIFORM. ACCURATE MANNER AS REQUIRED TO PROVIDE NEAT, STRAIGHT LINES FREE FROM DEFECTS. OVERLAPS 13. AND IMPERFECTIONS. WORK SHALL BE INSTALLED LEVEL, PLUMB OR FLUSH WITH ADJOINING MATERIALS (WHERE APPLICABLE). WORK OF EACH TRADE SHALL MEET OR EXCEED NATIONALLY RECOGNIZED AND/OR PUBLISHED STANDARDS. WHERE THE CONTRACT DOCUMENTS ARE MORE STRINGENT THAN THE AFOREMENTIONED STANDARDS WORK SHALL BE PERFORMED IN ACCORDANCE WITH SUCH.
 - COORDINATE WITH AUTHORITIES HAVING JURISDICTION AND PROVIDE ALL REQUIRED TEMPORARY FIRE AND LIFE SAFETY PROVISIONS DURING
- PROVIDE PORTABLE FIRE EXTINGUISHERS DURING CONSTRUCTION AS REQUIRED BY CODE AND AUTHORITY HAVING JURISDICTION. THESE NOTES APPLY TO ALL CONTRACT DRAWINGS.
- UNLESS INDICATED OTHERWISE, KEYNOTES INCLUDED ON THE DEMOLITION DRAWINGS ARE TYPICAL AND APPLY TO ALL SIMILAR CONDITIONS THROUGHOUT.
- REMOVAL INCLUDES FASTENERS, EMBEDMENT, ACCESSORIES ETC. ASSOCIATED WITH THE PARTICULAR ITEM INDICATED TO BE REMOVED OR DEMOLISHED. 18. UPON REMOVALS, INSPECT FOR SUBSTRATE DAMAGE NOT CAUSED AND / OR CAUSED BY DEMOLITION. DOCUMENT, MEASURE AND REPORT SUBSTRATE
- DAMAGE TO THE ARCHITECT/OWNER.
- REPAIR ANY SUBSTRATE DAMAGE CAUSED BY DEMOLITION AT NO ADDITIONAL COST TO THE OWNER.
- IN ORDER TO COMPLETE THE NEW WORK INCLUDED IN THESE CONTRACT DOCUMENTS, ADDITIONAL REMOVALS AND DEMOLITION MAY BE NECESSARY AND ARE INDICATED IN THE SCOPE FOR NEW WORK.

Housing Authority of New Have

OWNER

HOUSING AUTHORITY OF NEW HAVEN 360 ORANGE STREET NEW HAVEN. CT

ARCHITECT



ENGINEERS

FOR BIDDING

JULY 22 2024

ESSEX TOWNHOUSES FIRE DAMAGE REPAIR & EXTERIOR **IMPROVEMENTS** 1134 Quinnipiac Ave, New Haven, CT

MARK DATE DESCRIPTION

PROJECT NO:

CWA PROJECT NO.: 2401 DRAWN BY: CHK'D BY:


COPYRIGHT

GENERAL INFORMATION & CODE NOTES

G003


8/1/2024 12:24:02 PM


Autodesk Docs://2401 - Essex Townhouses Fire Damage Repair/2401 - Essex Townhouses Fire Damage Repair R24.rvt

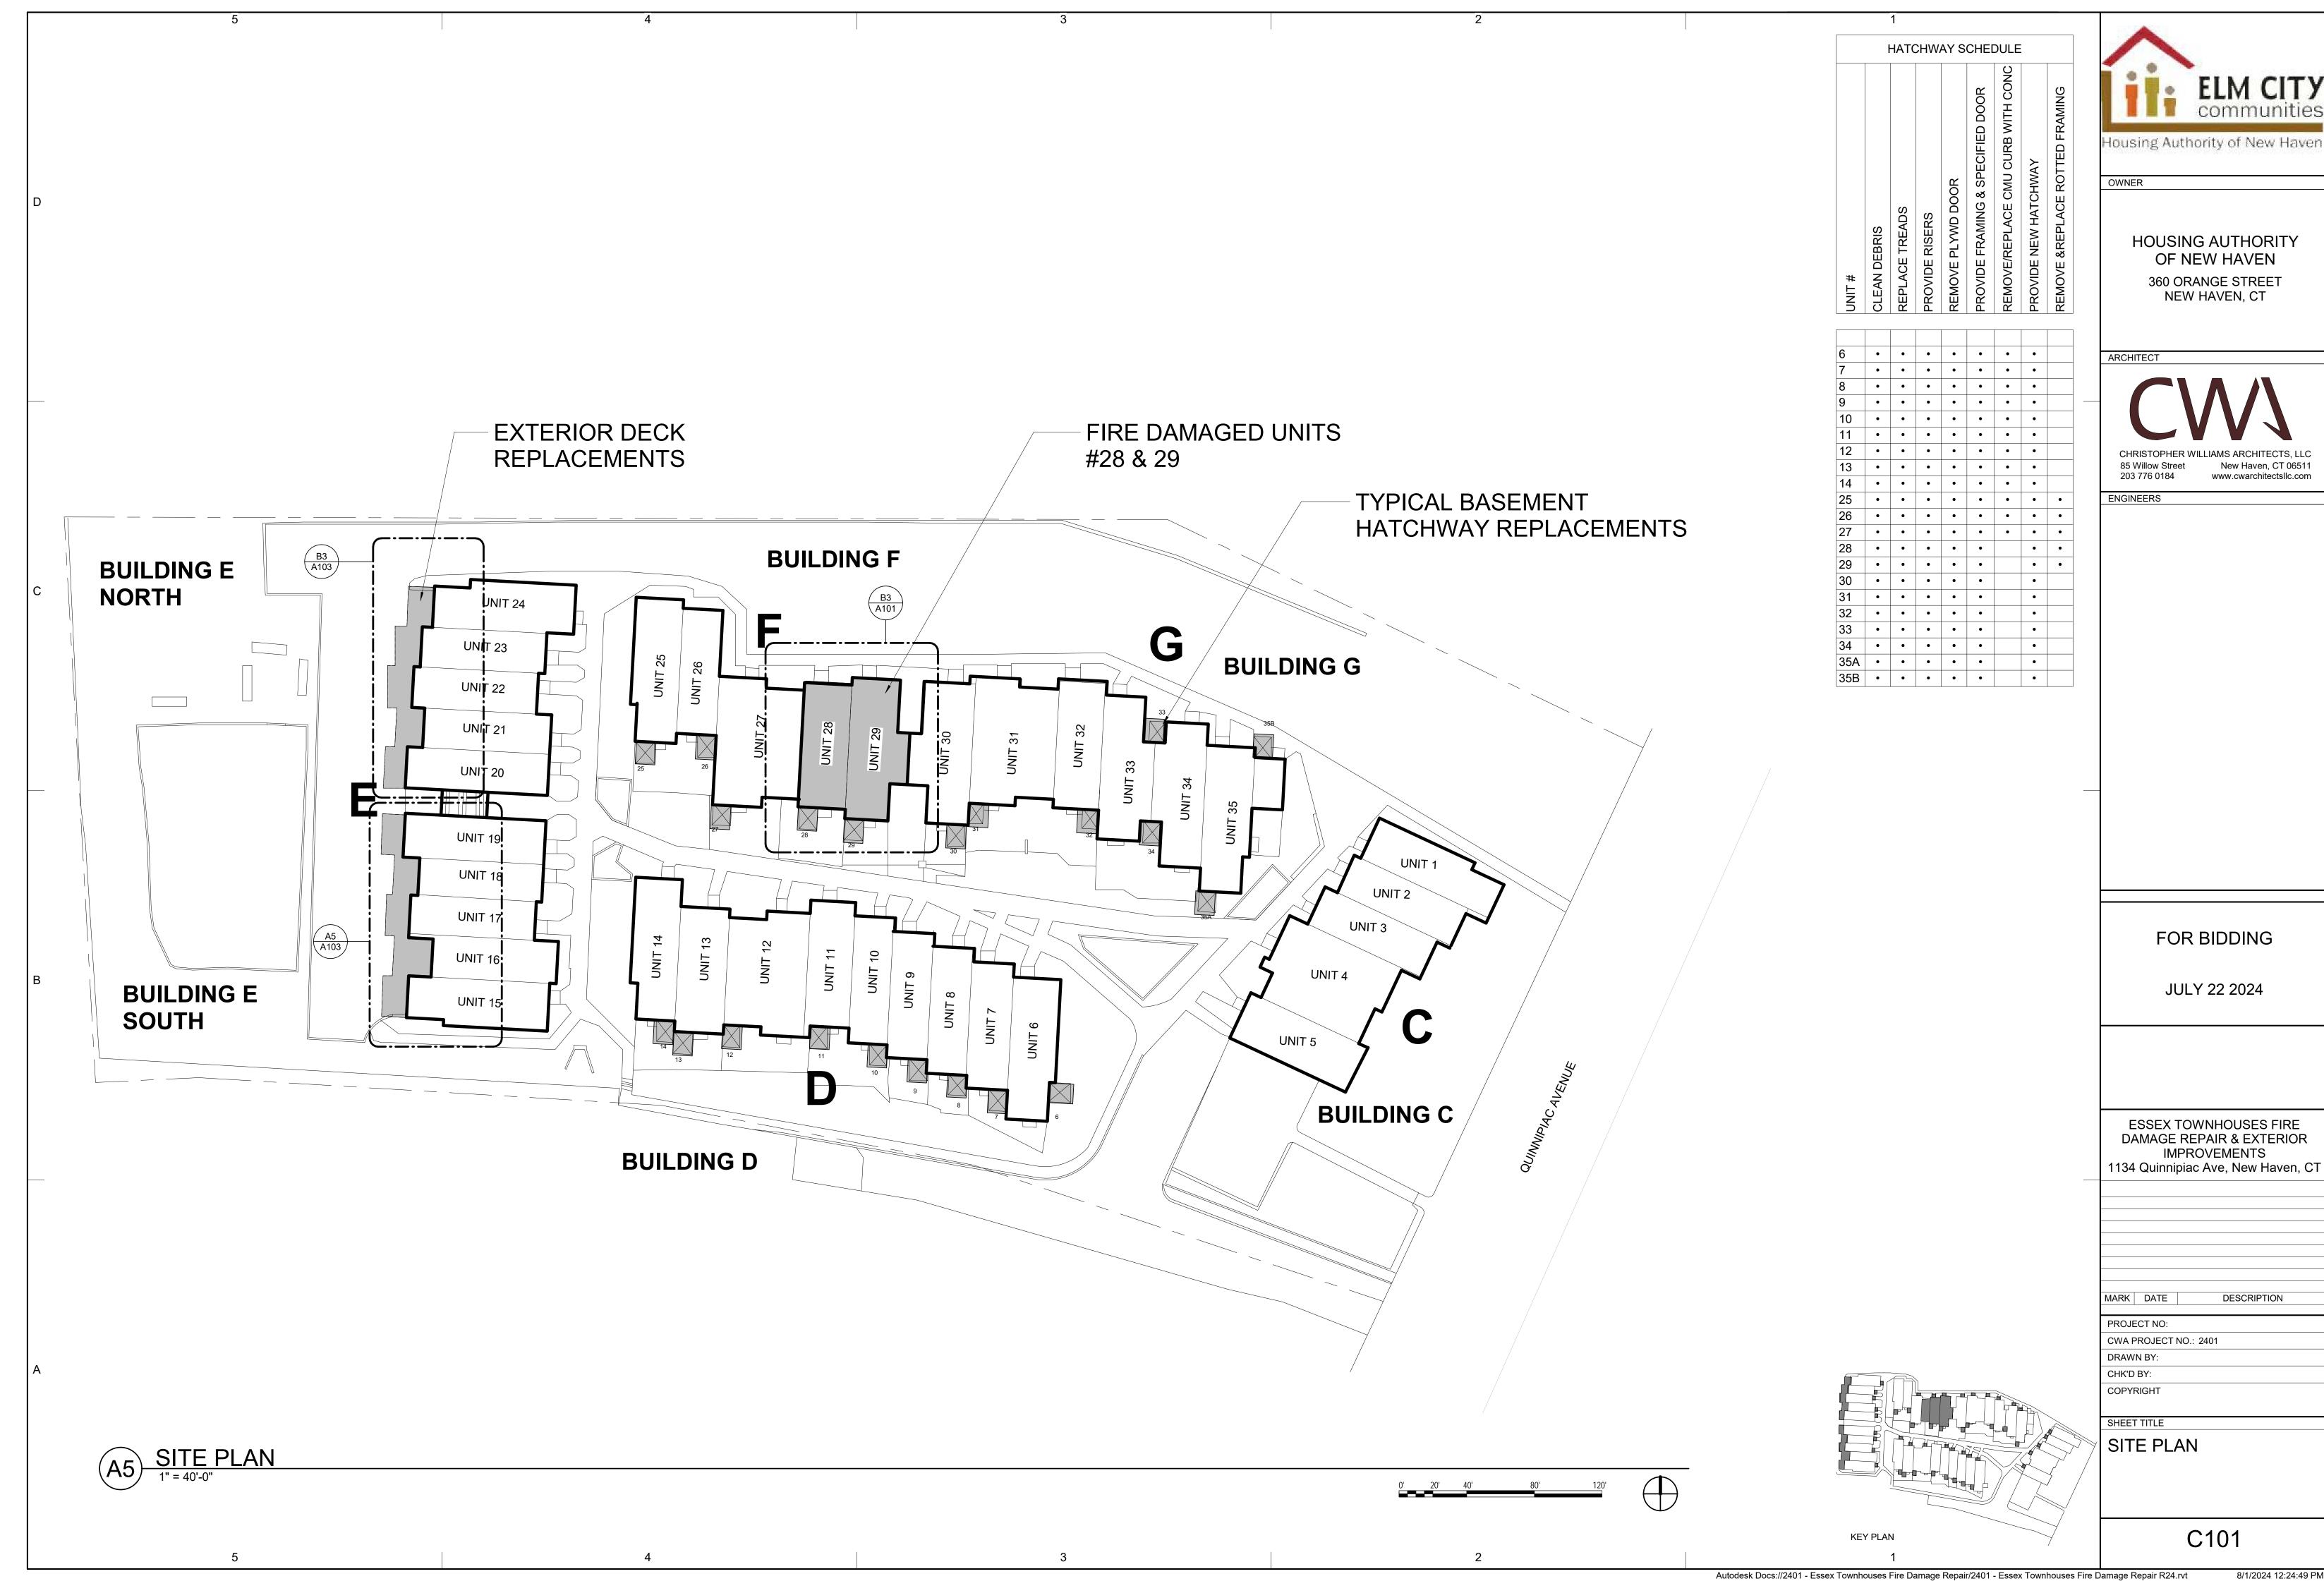



communities


Housing Authority of New Haven

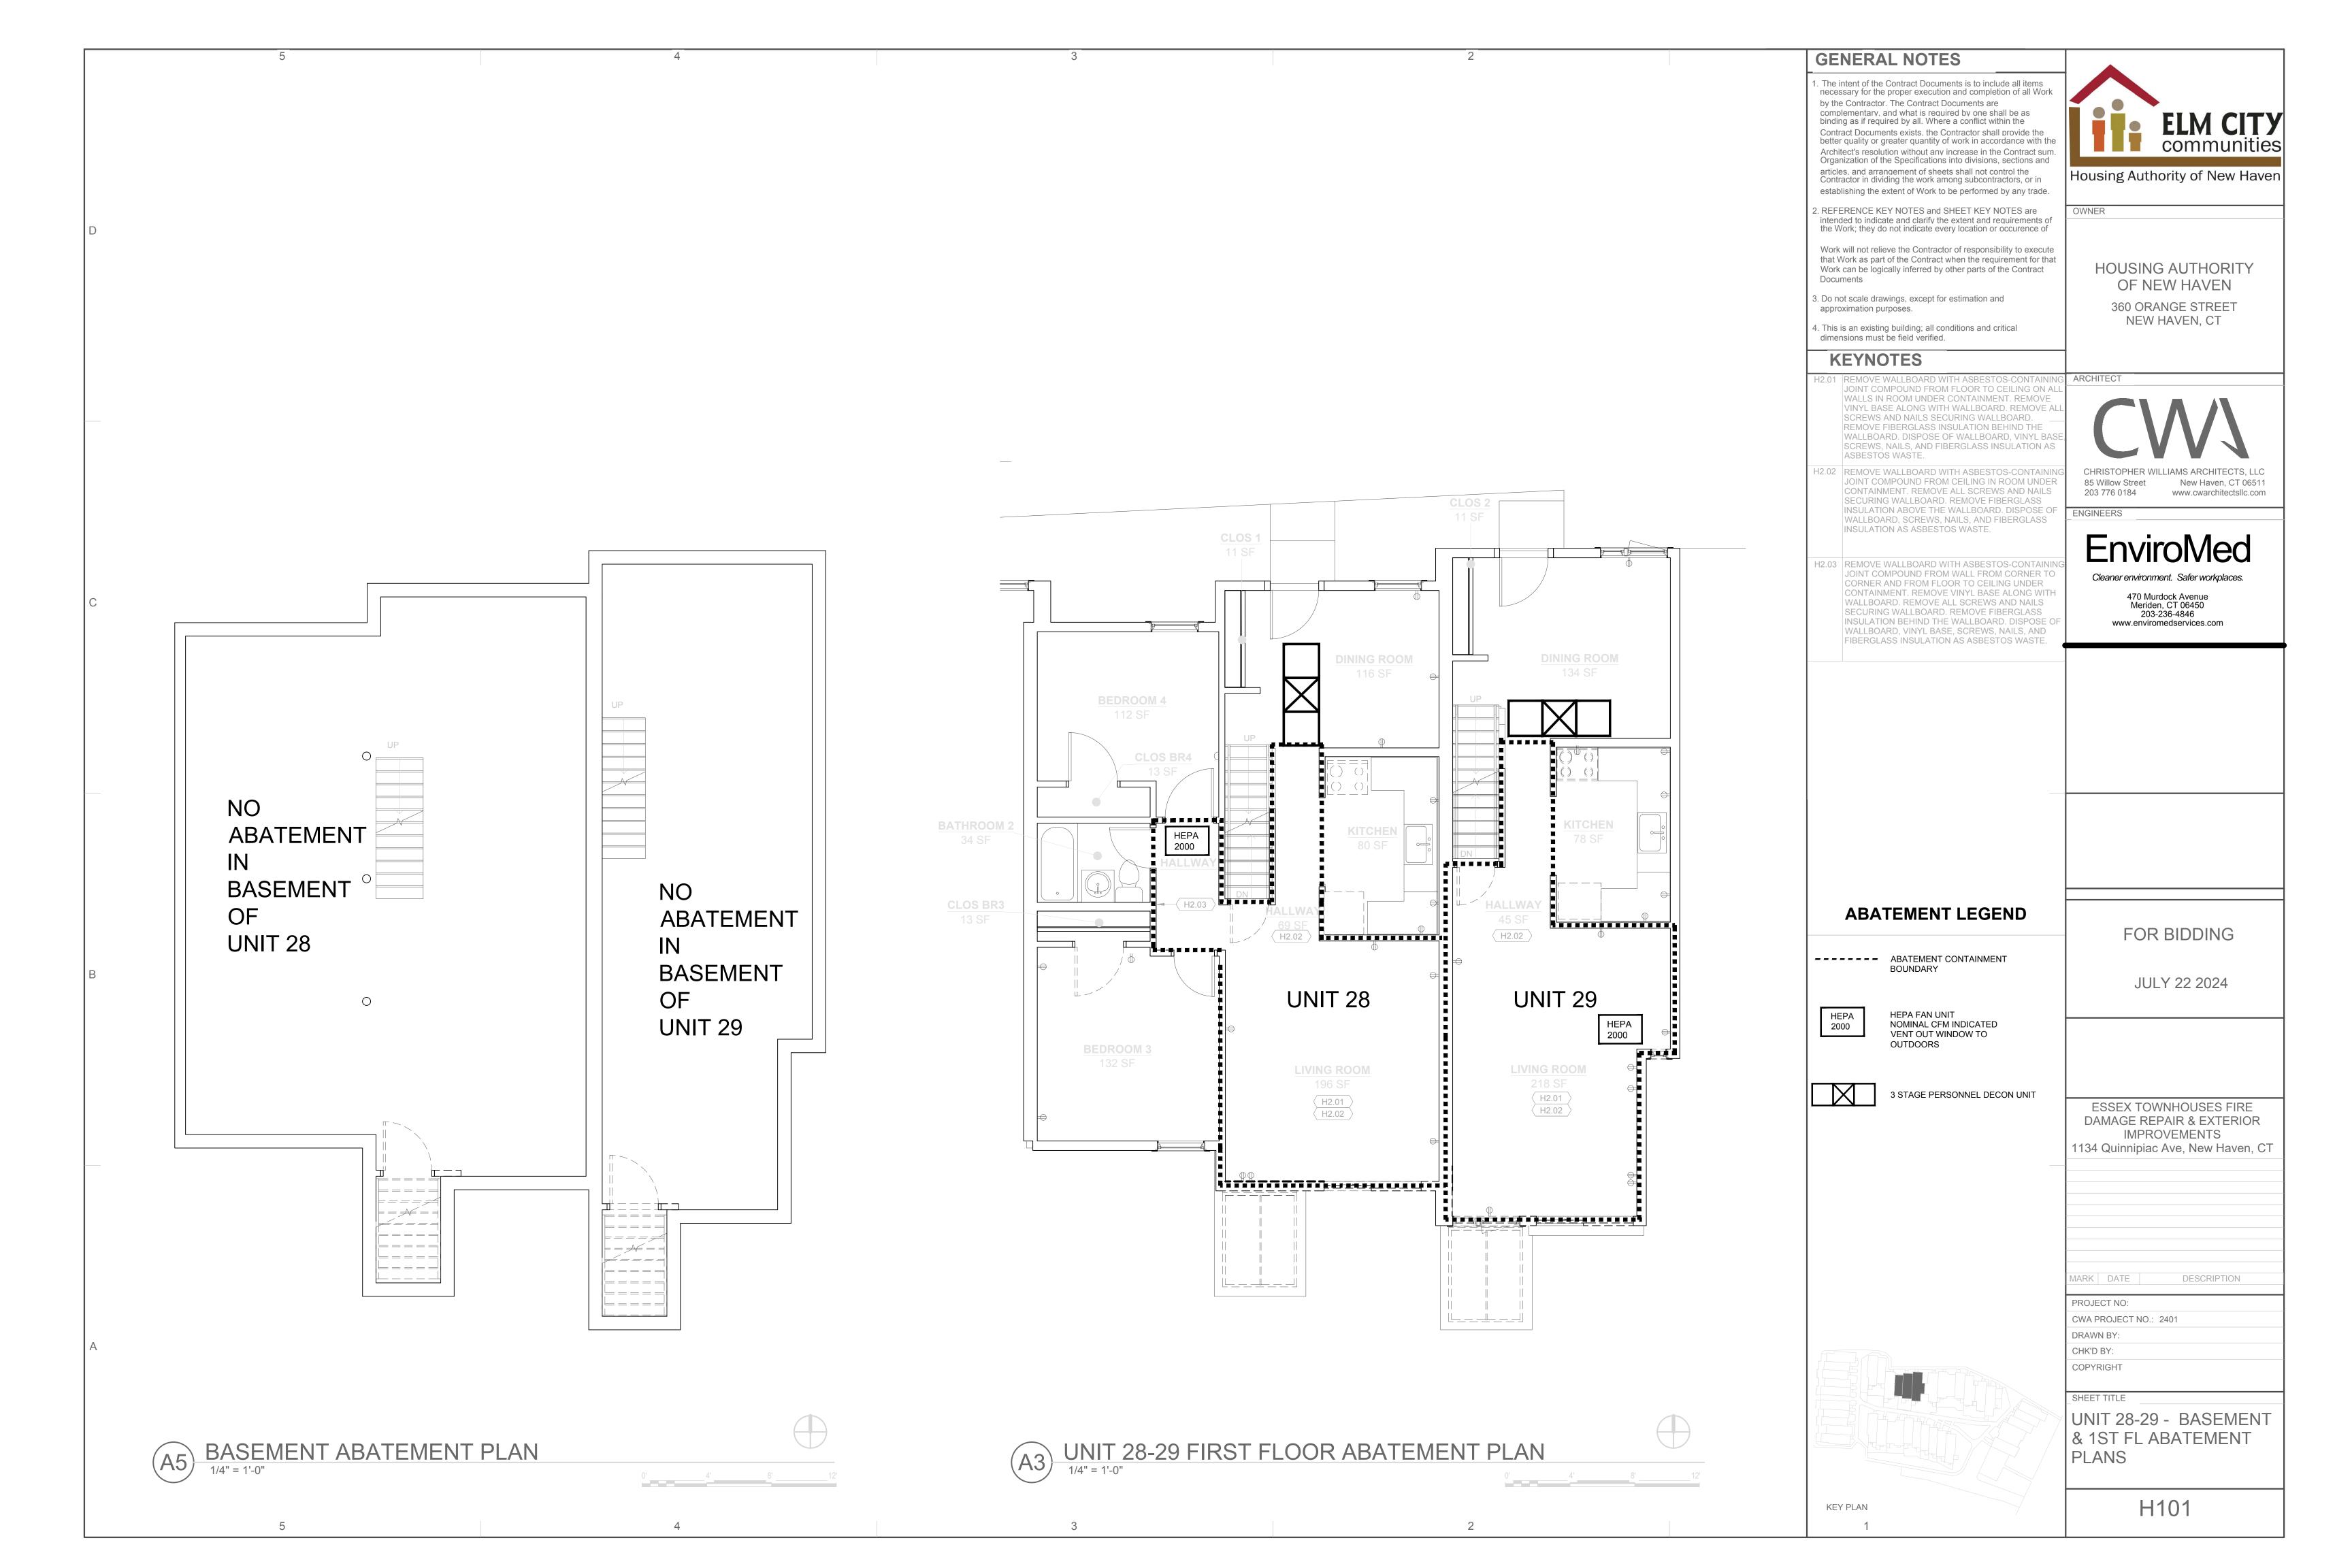


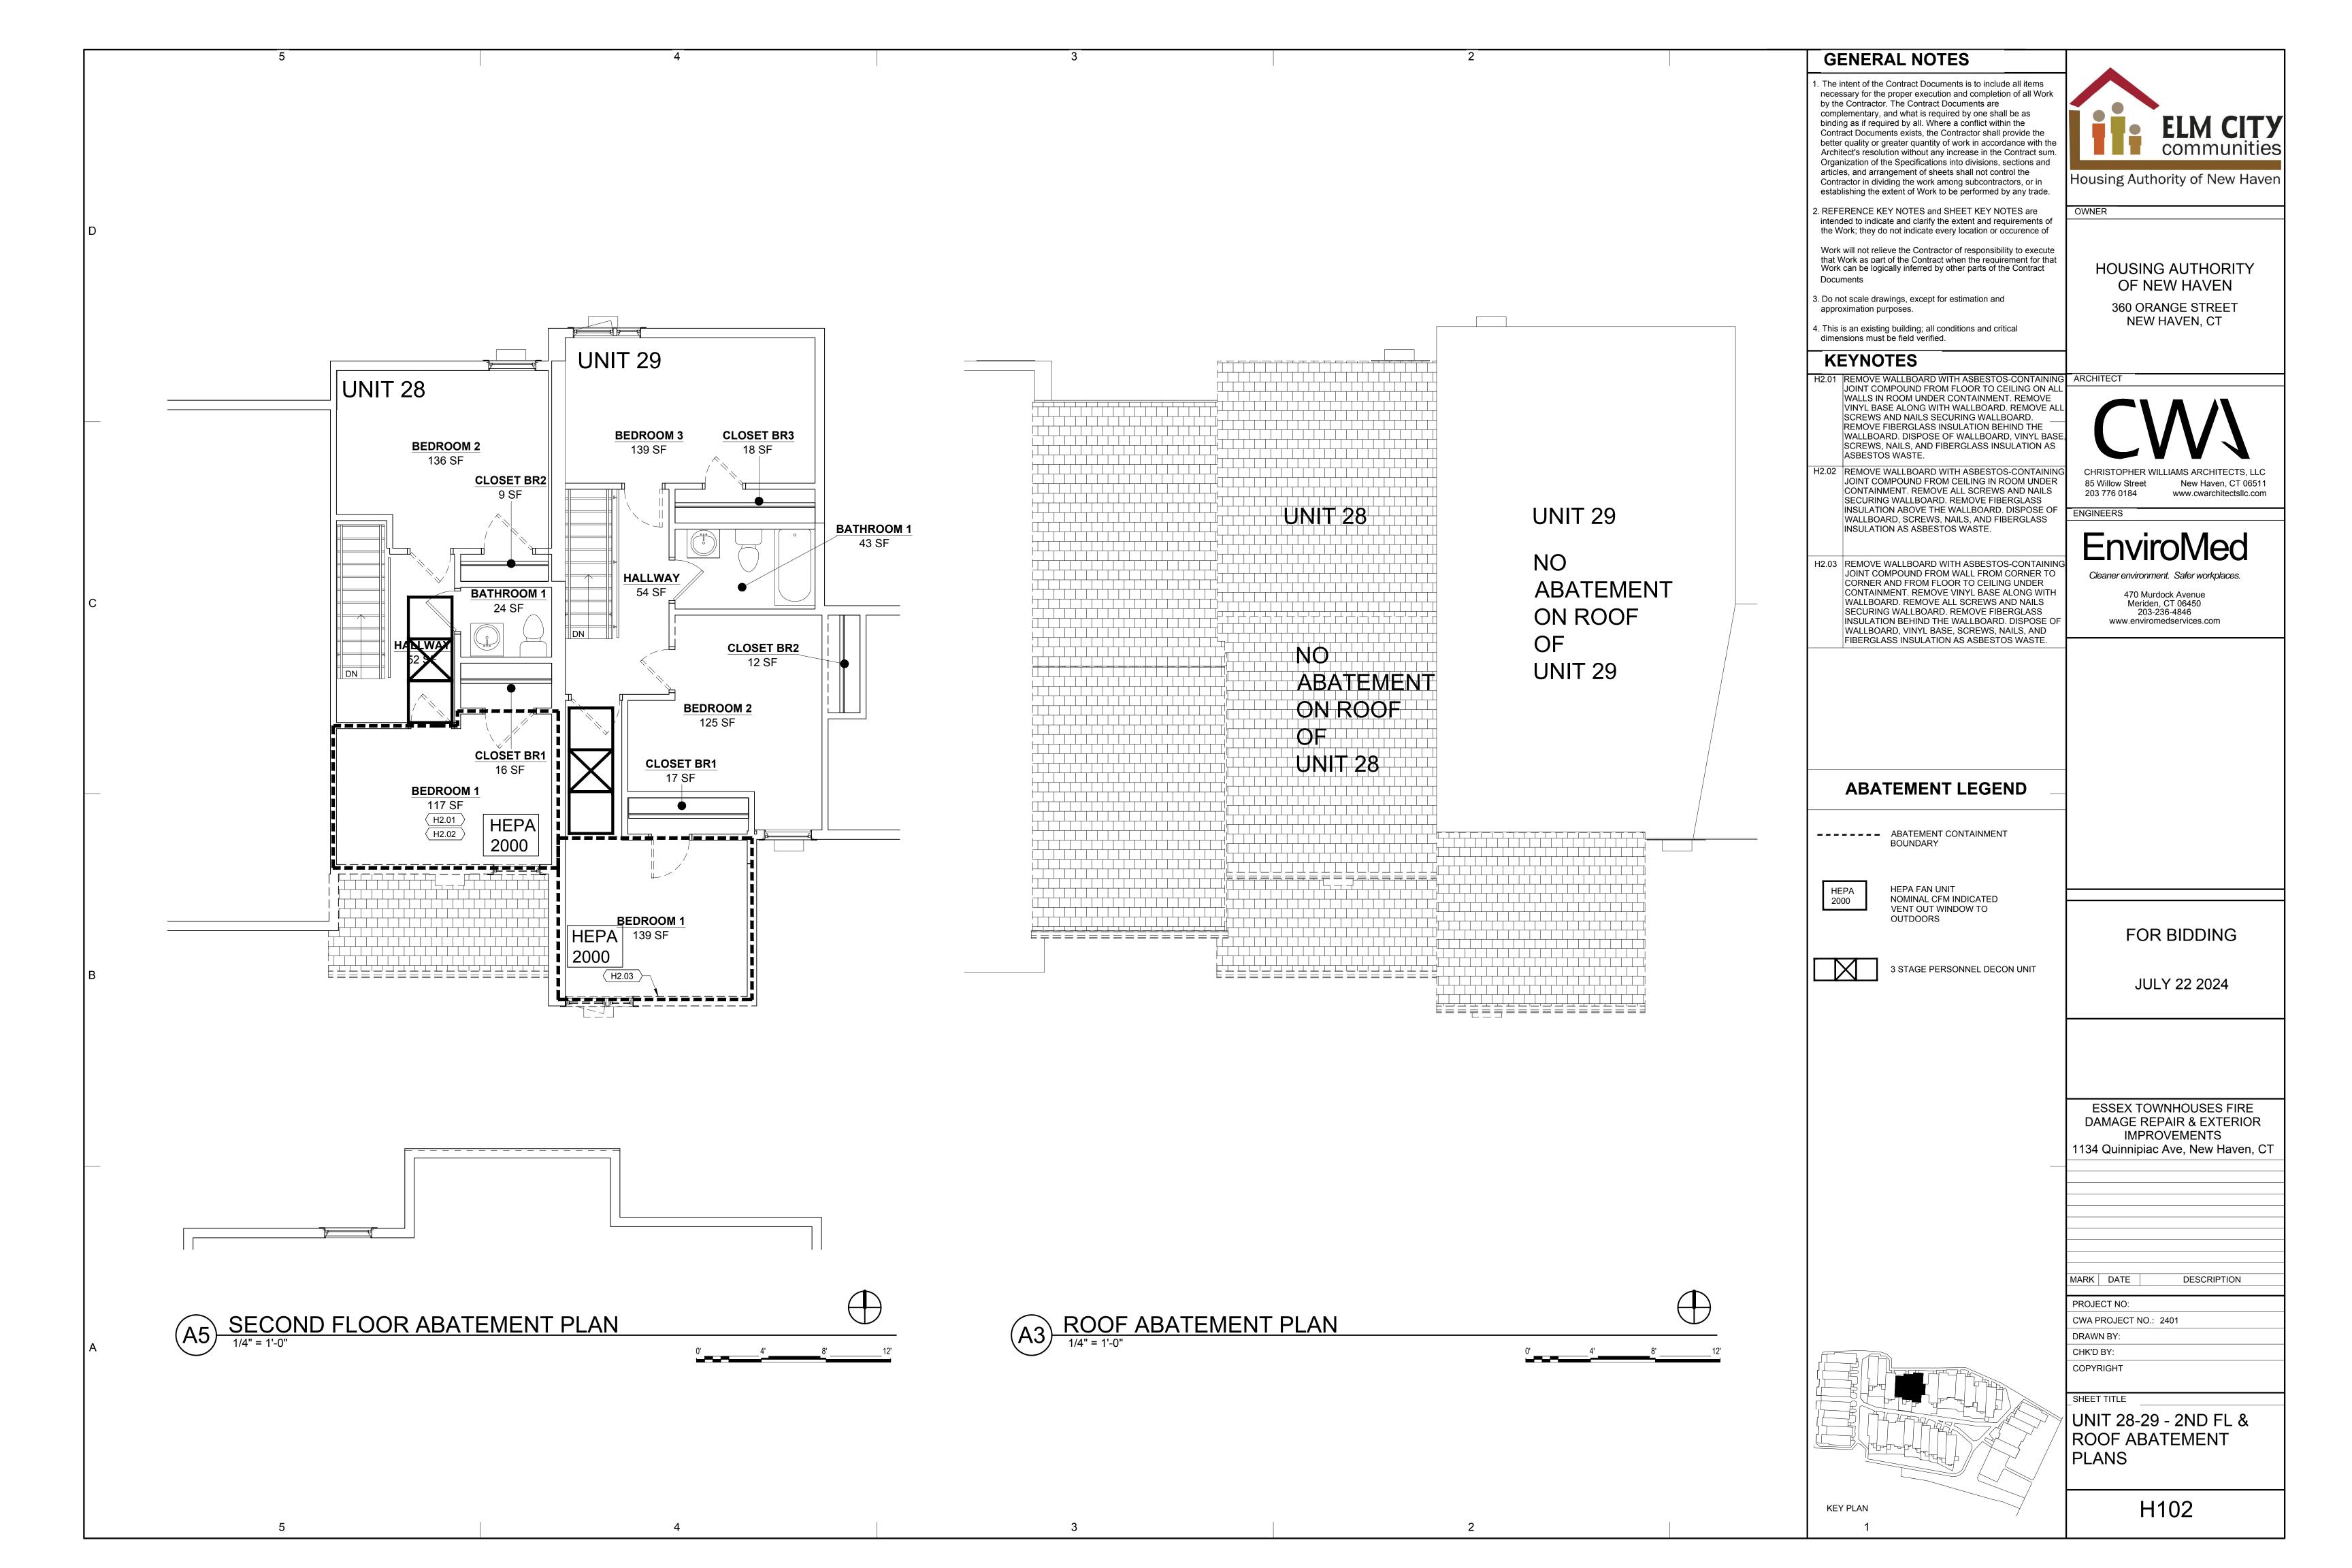


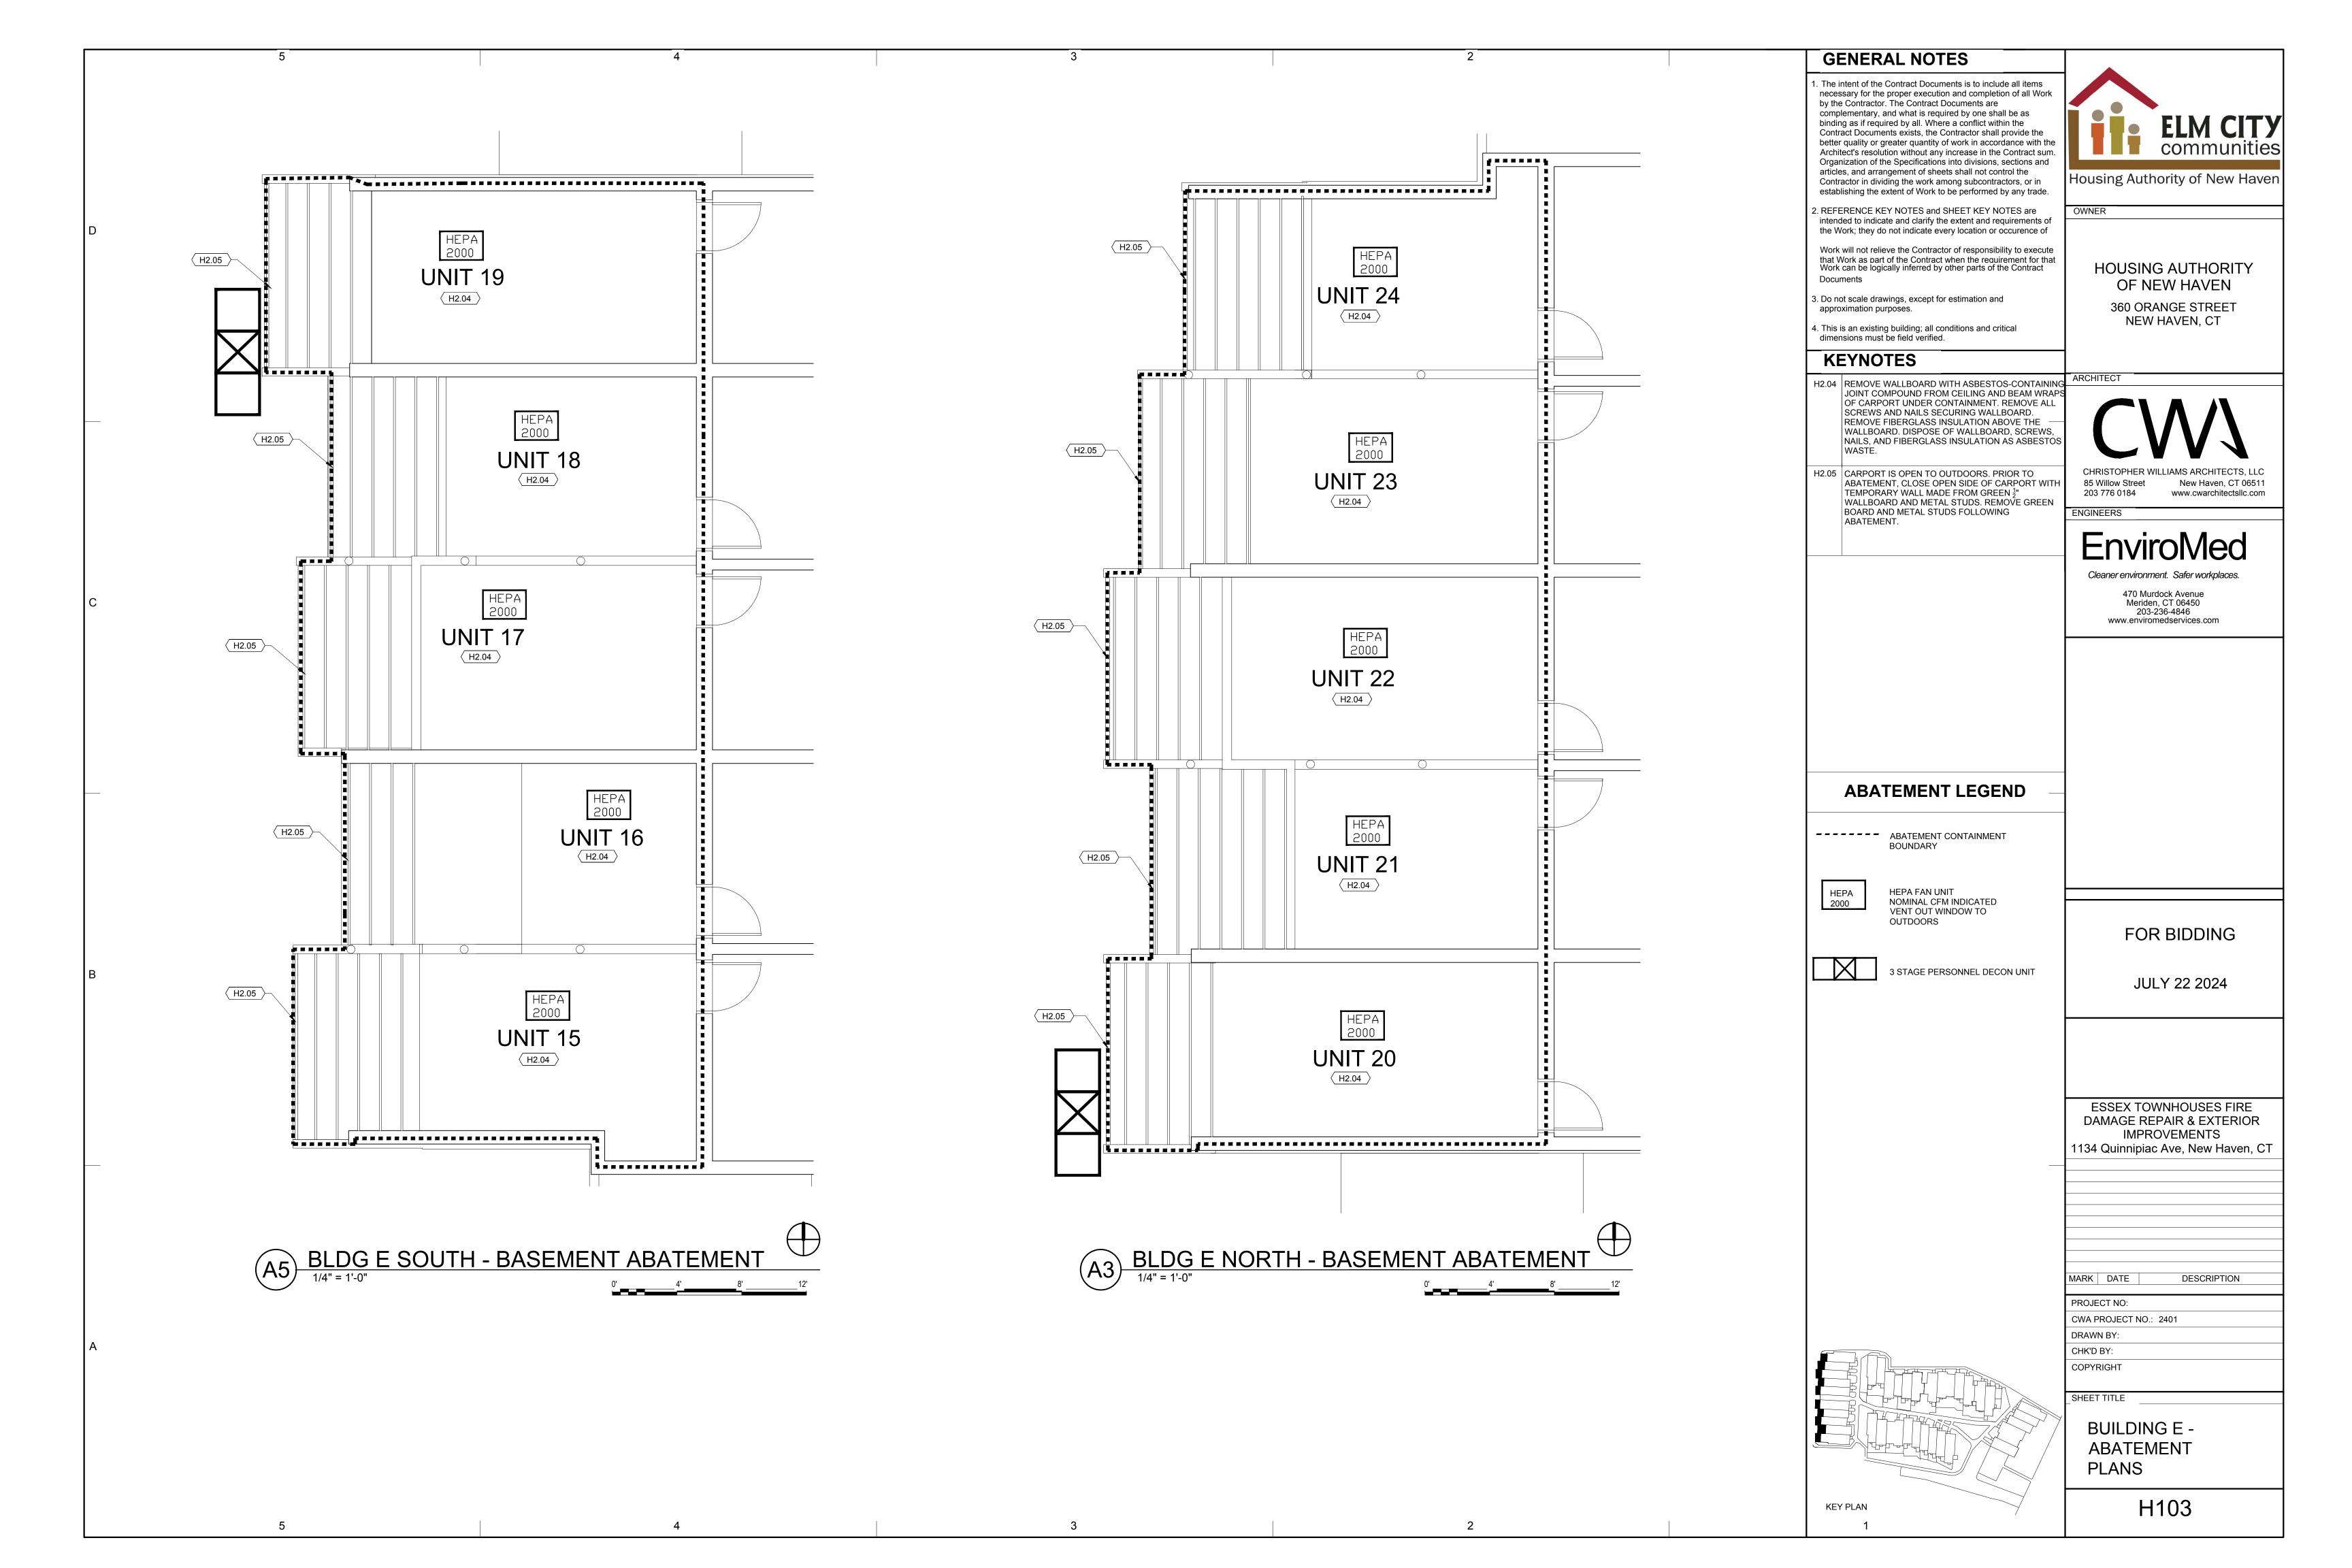


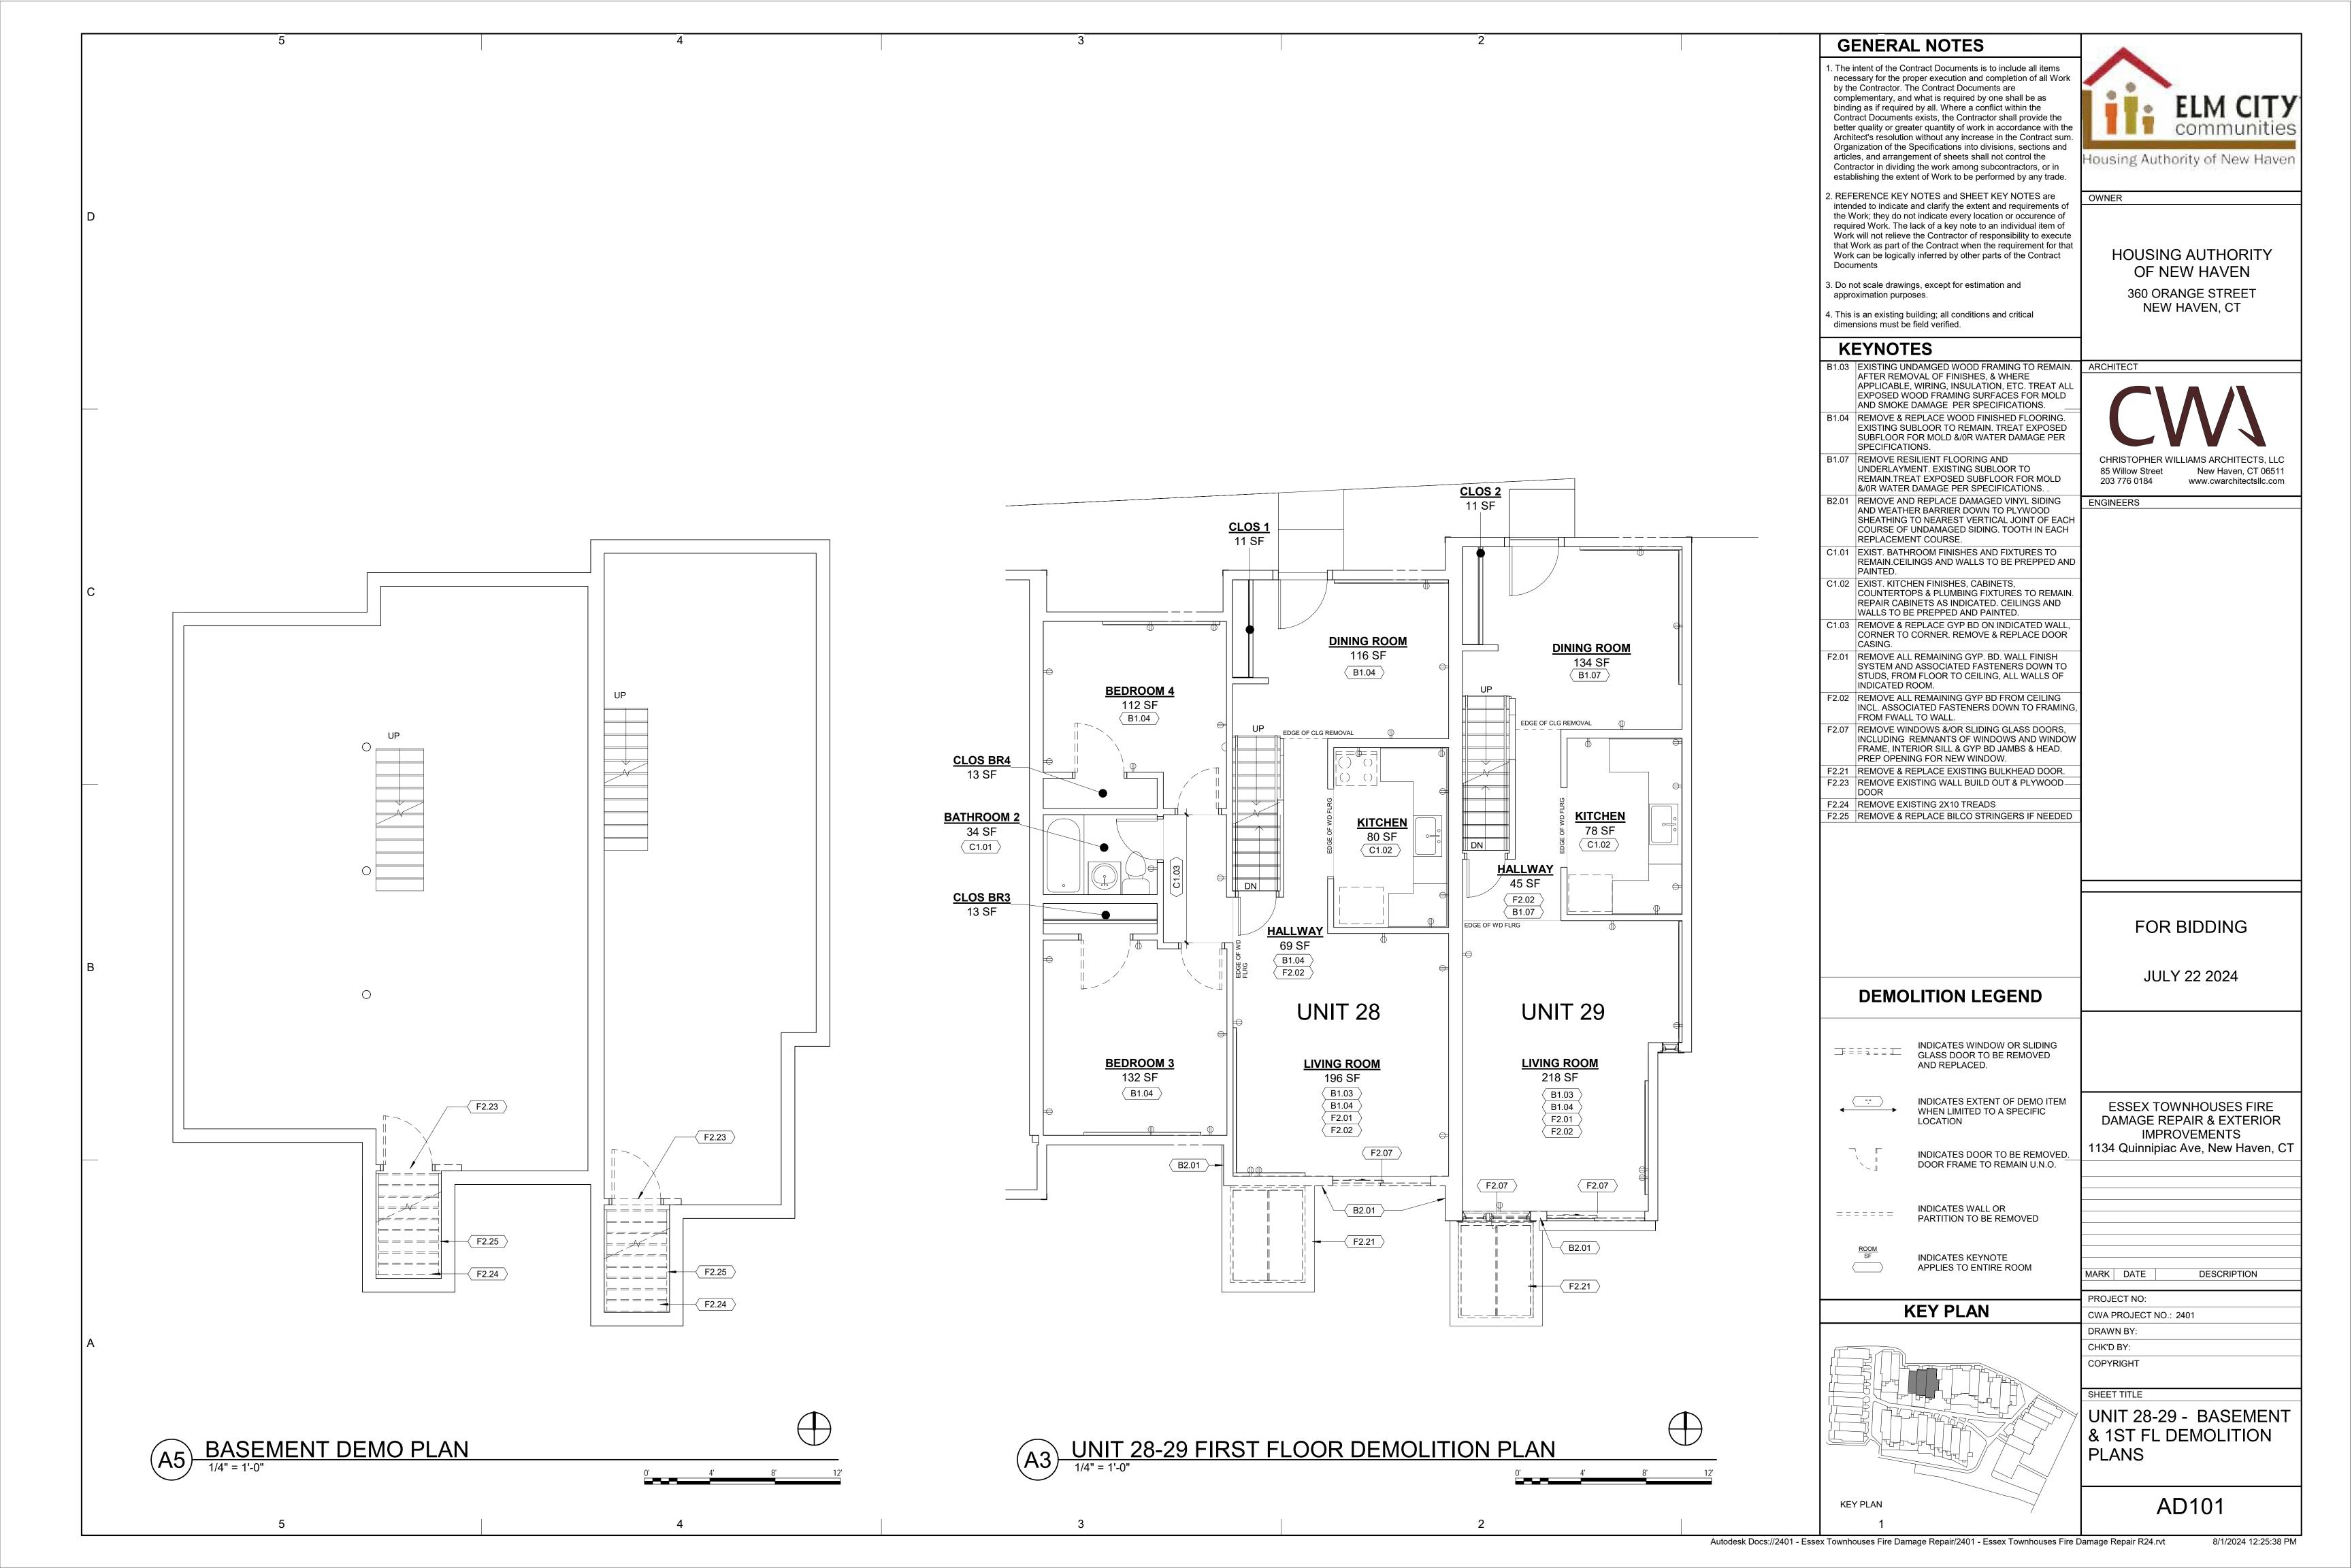


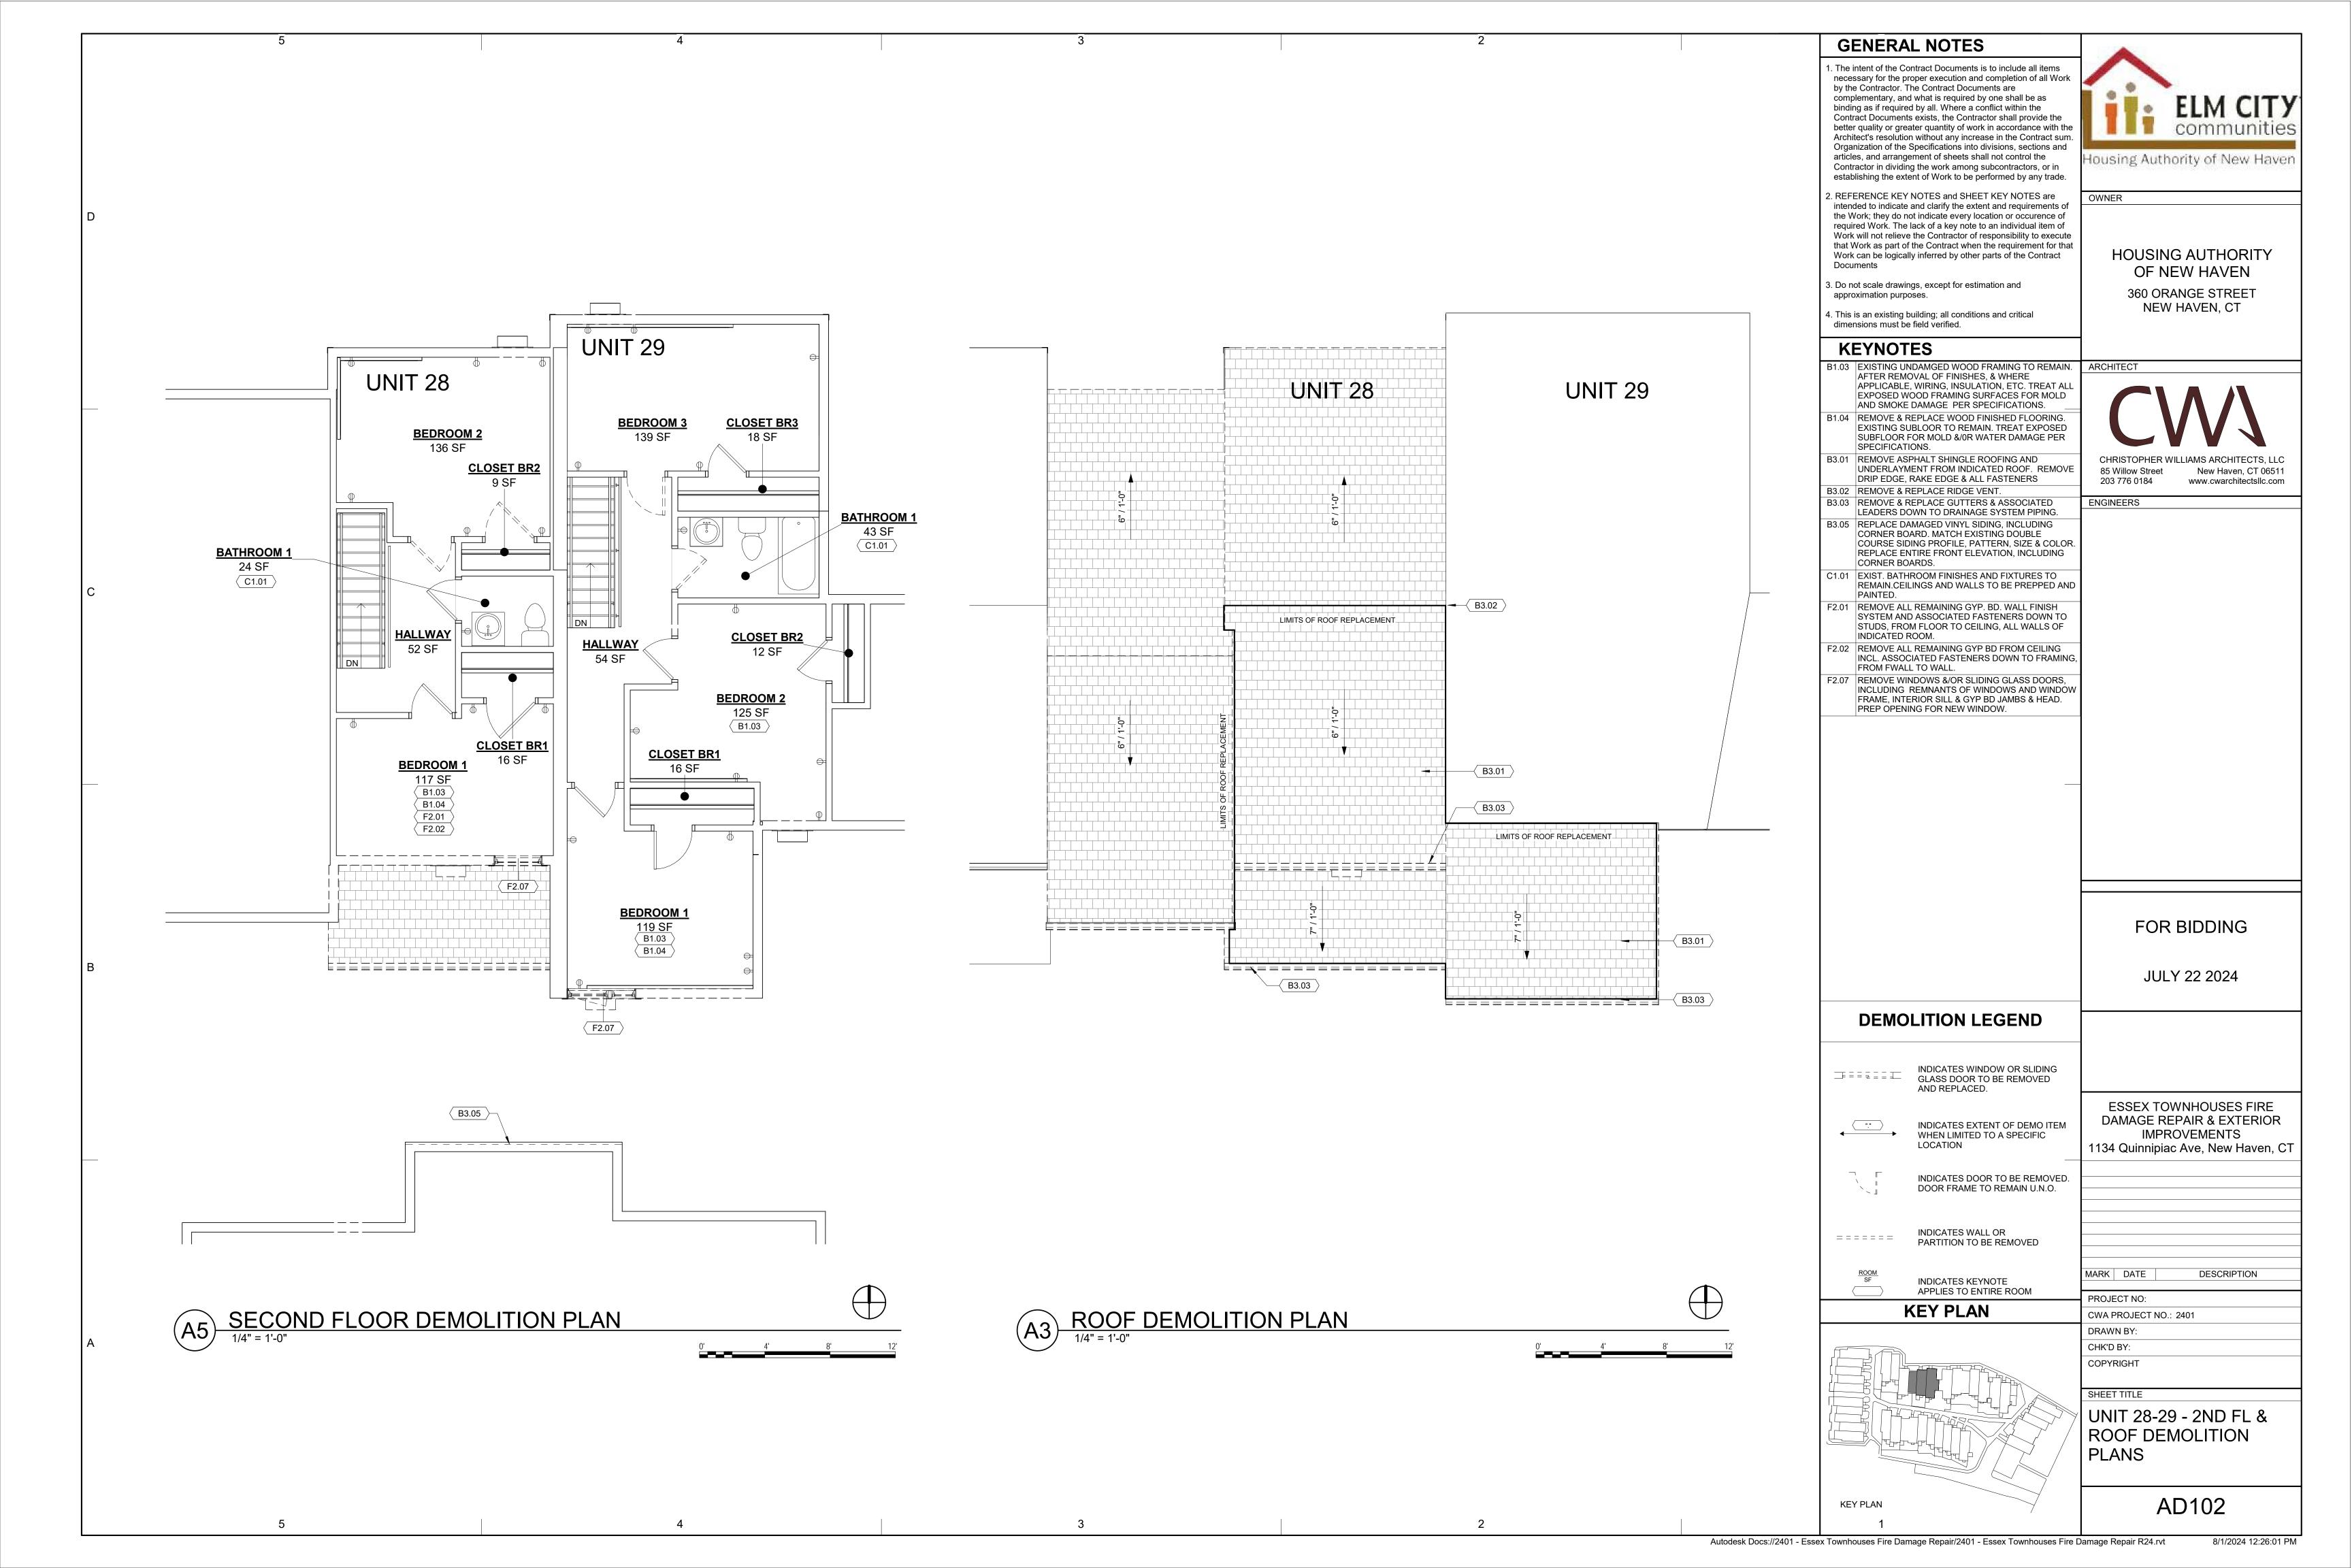


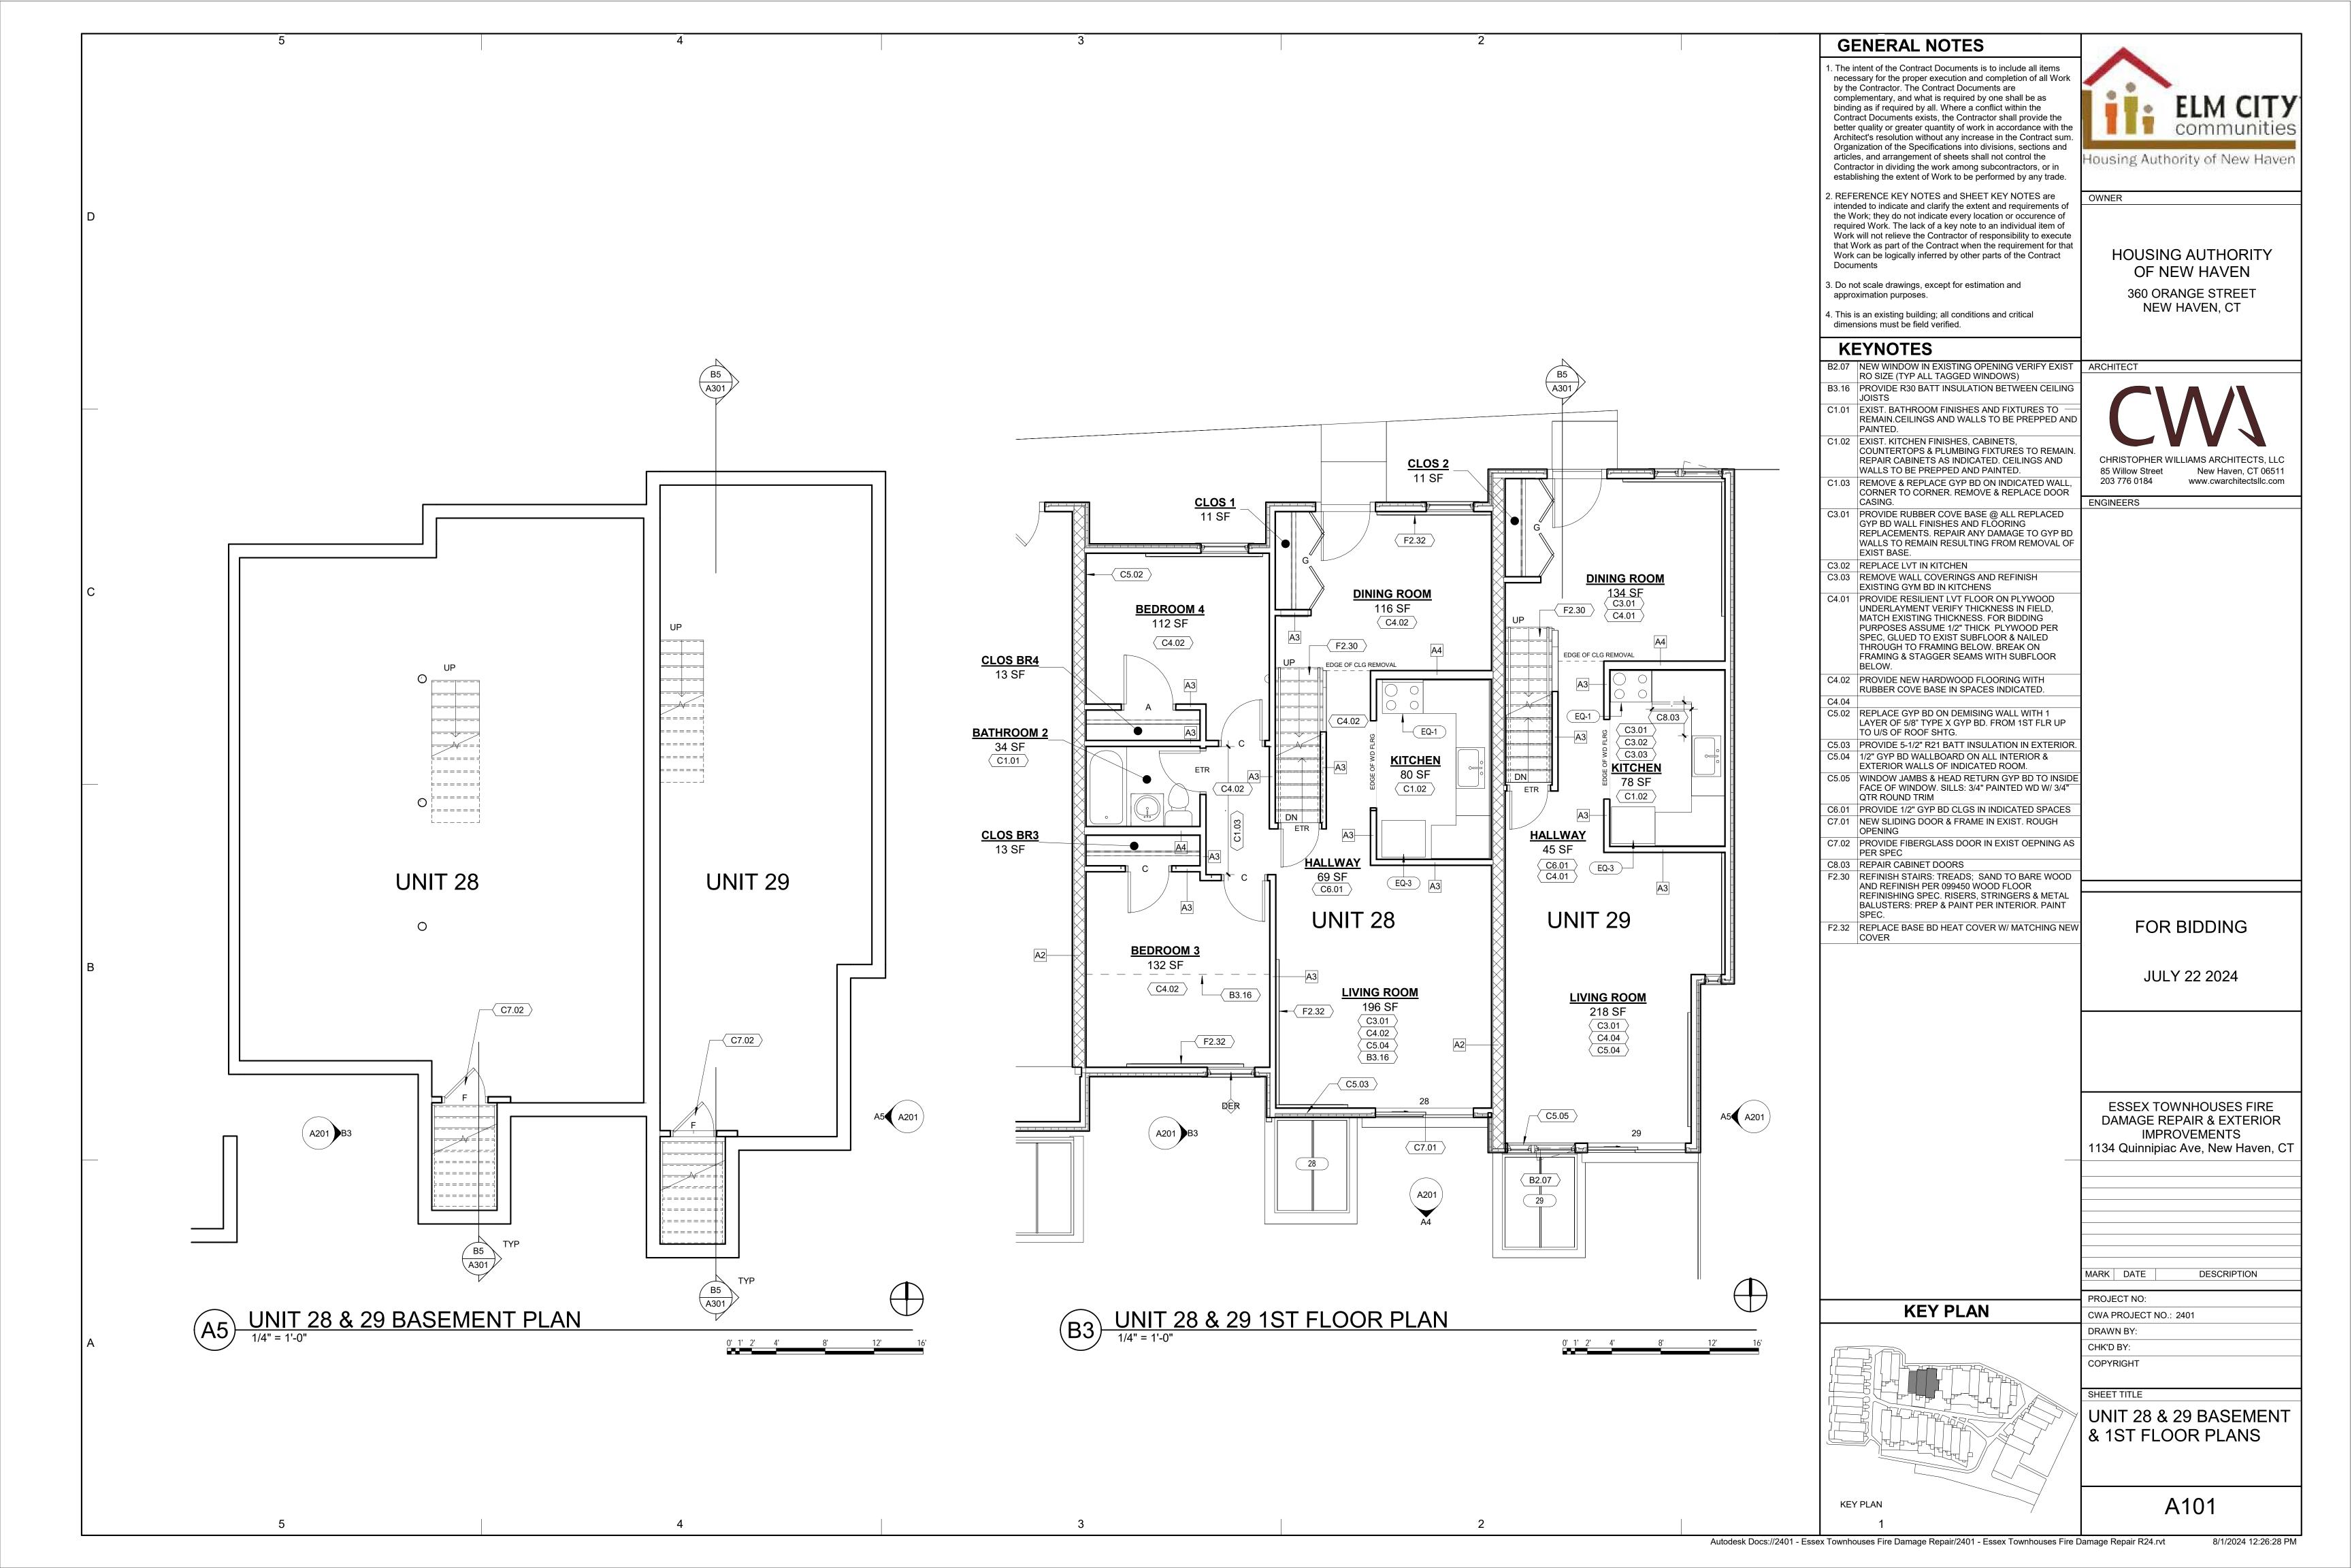


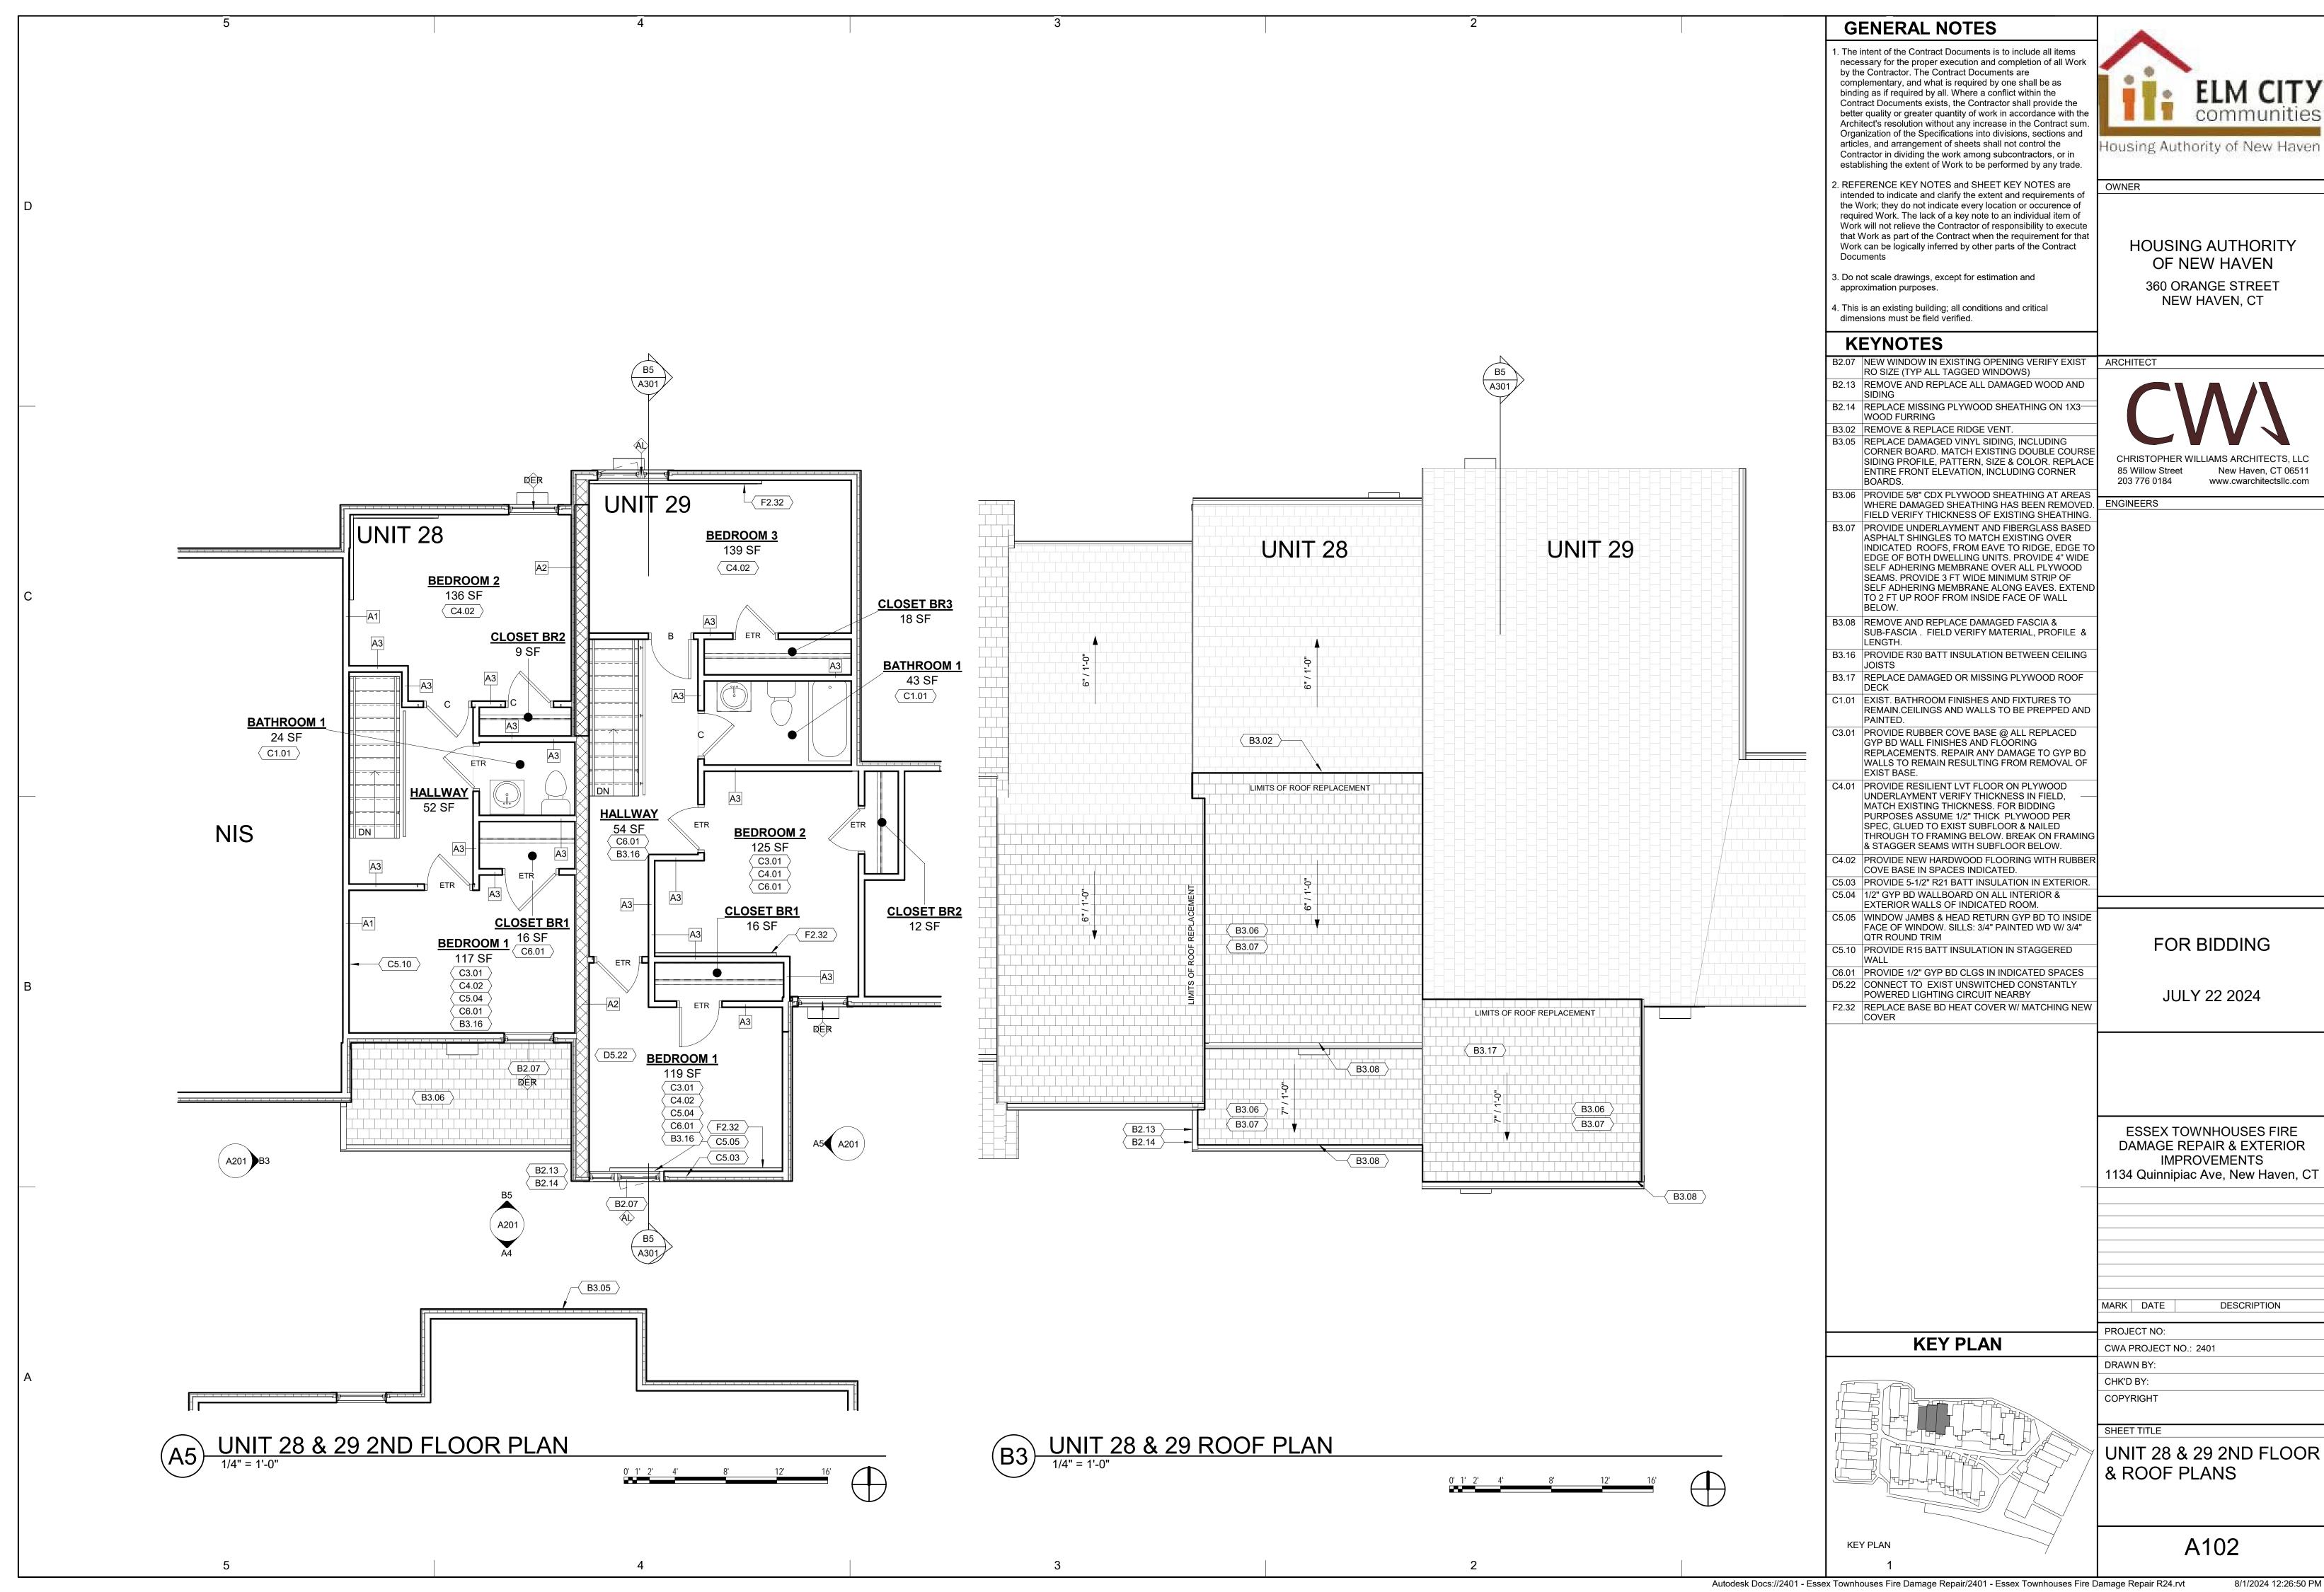


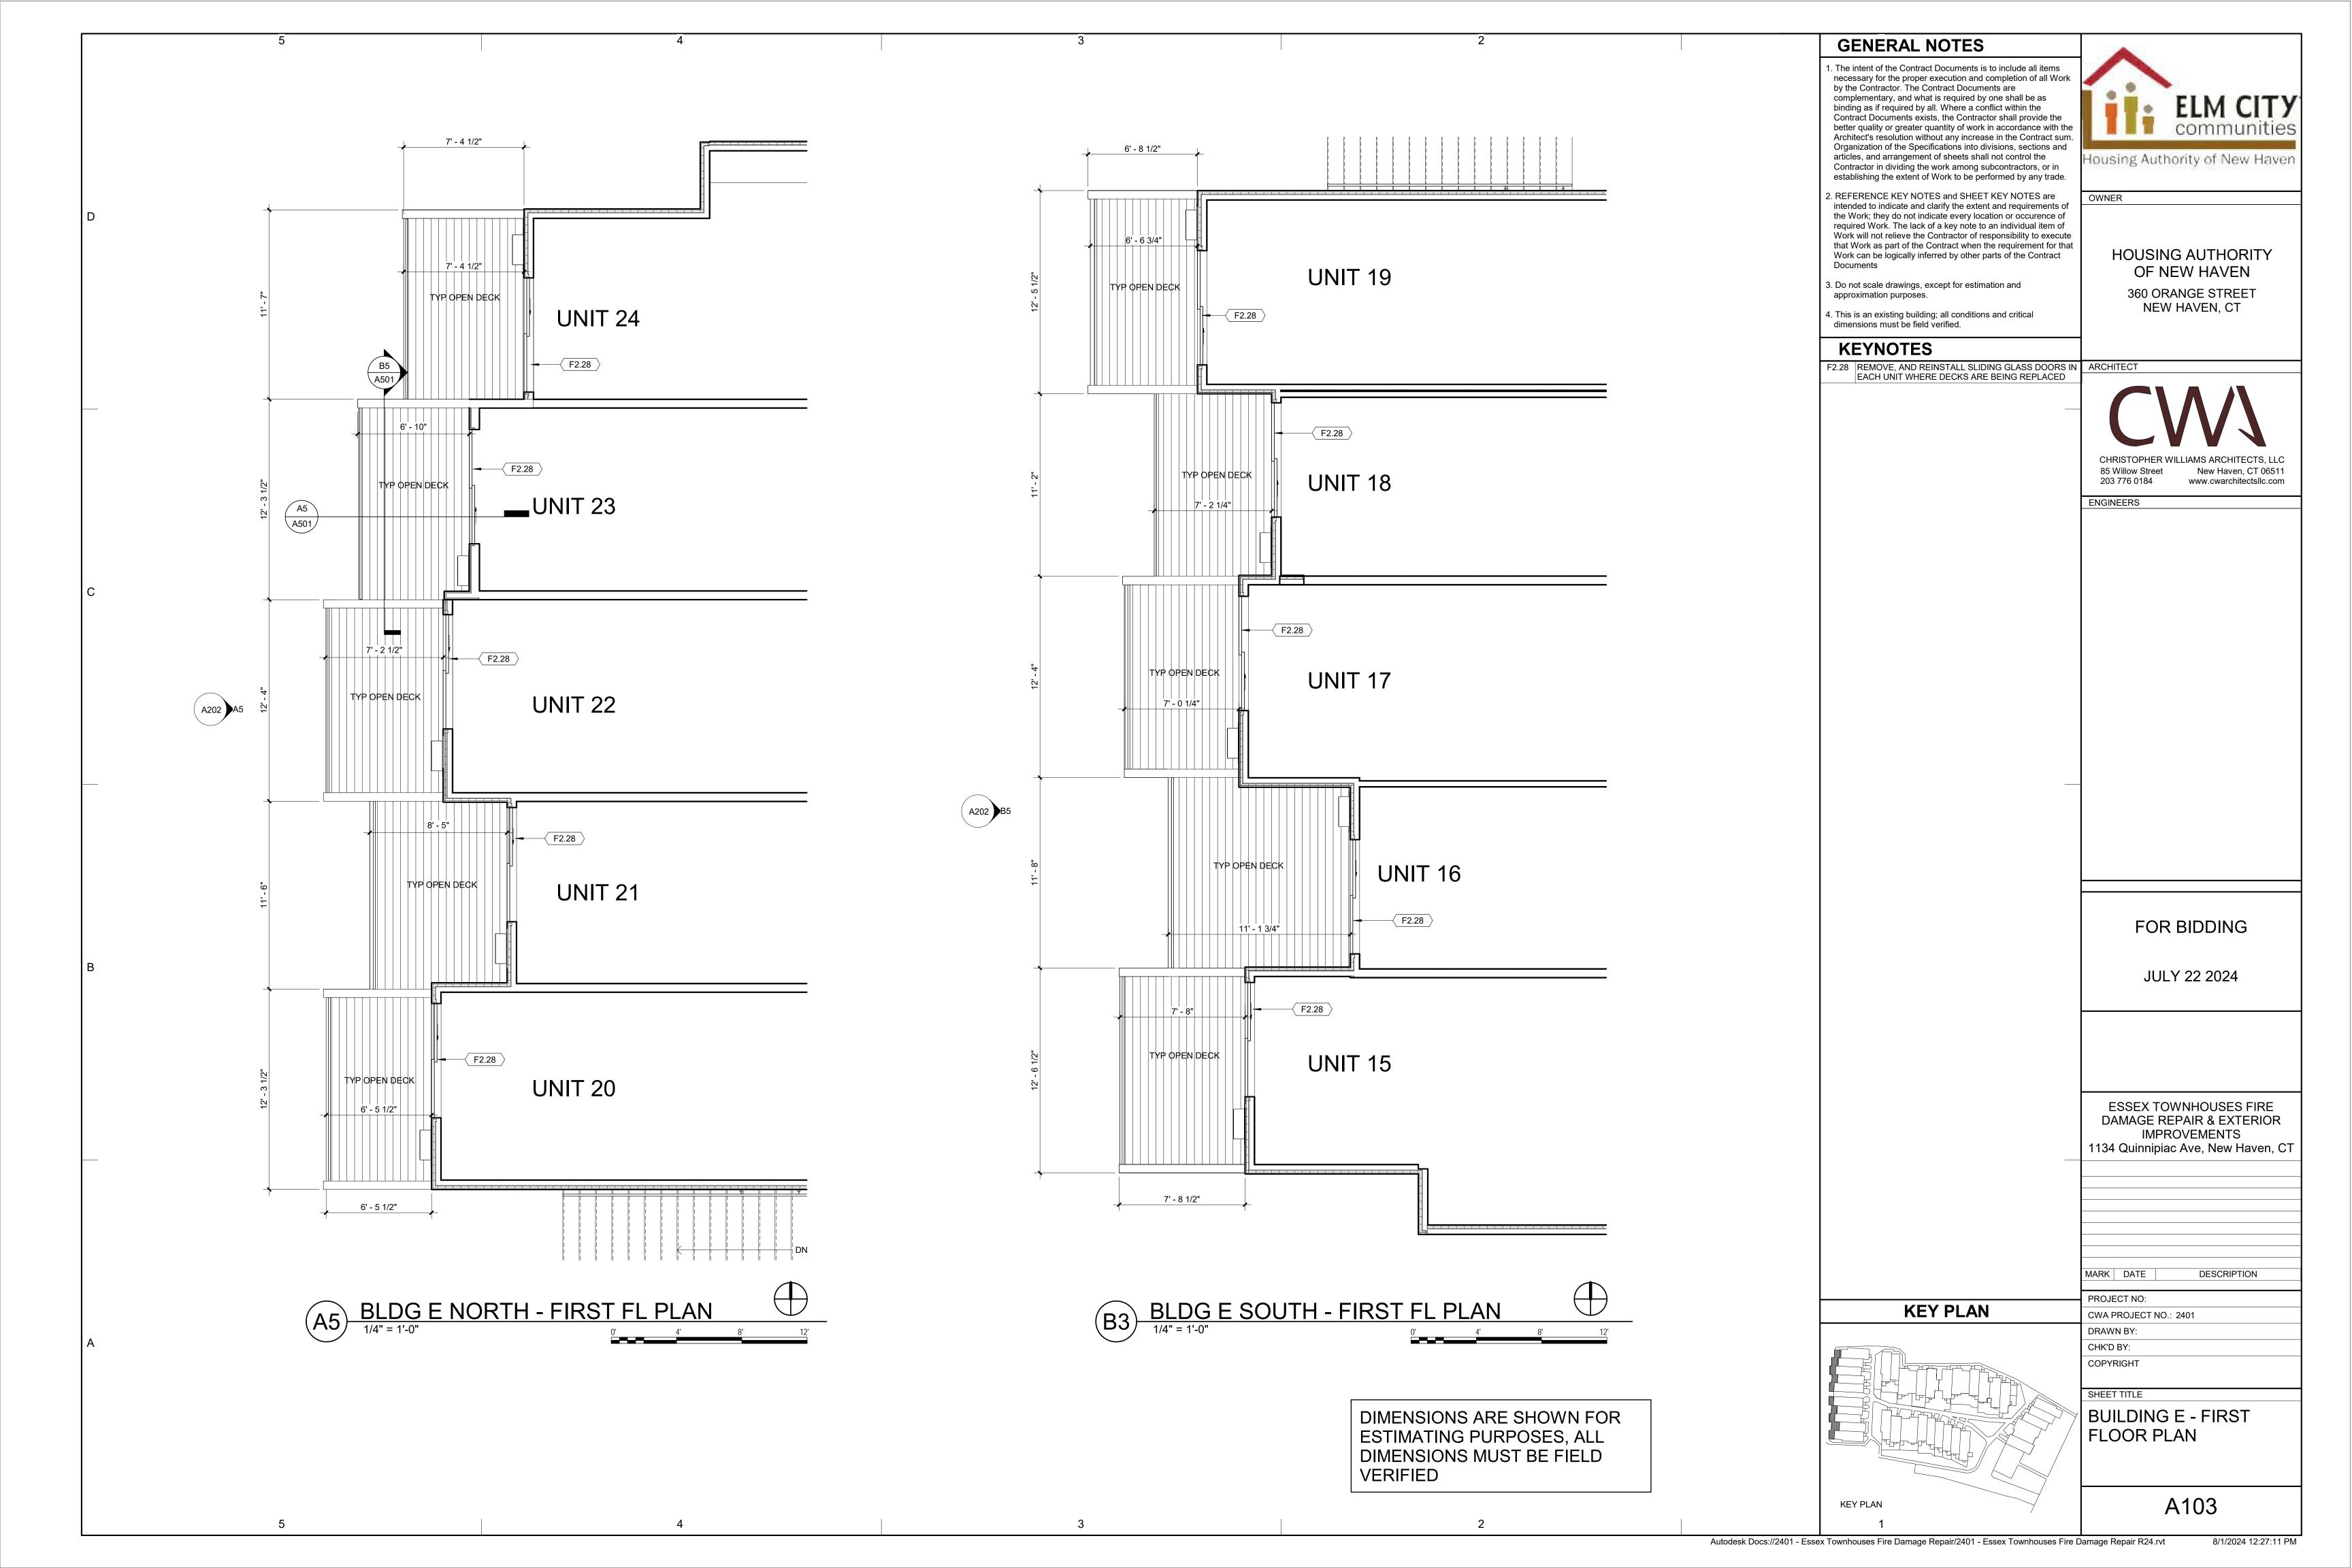


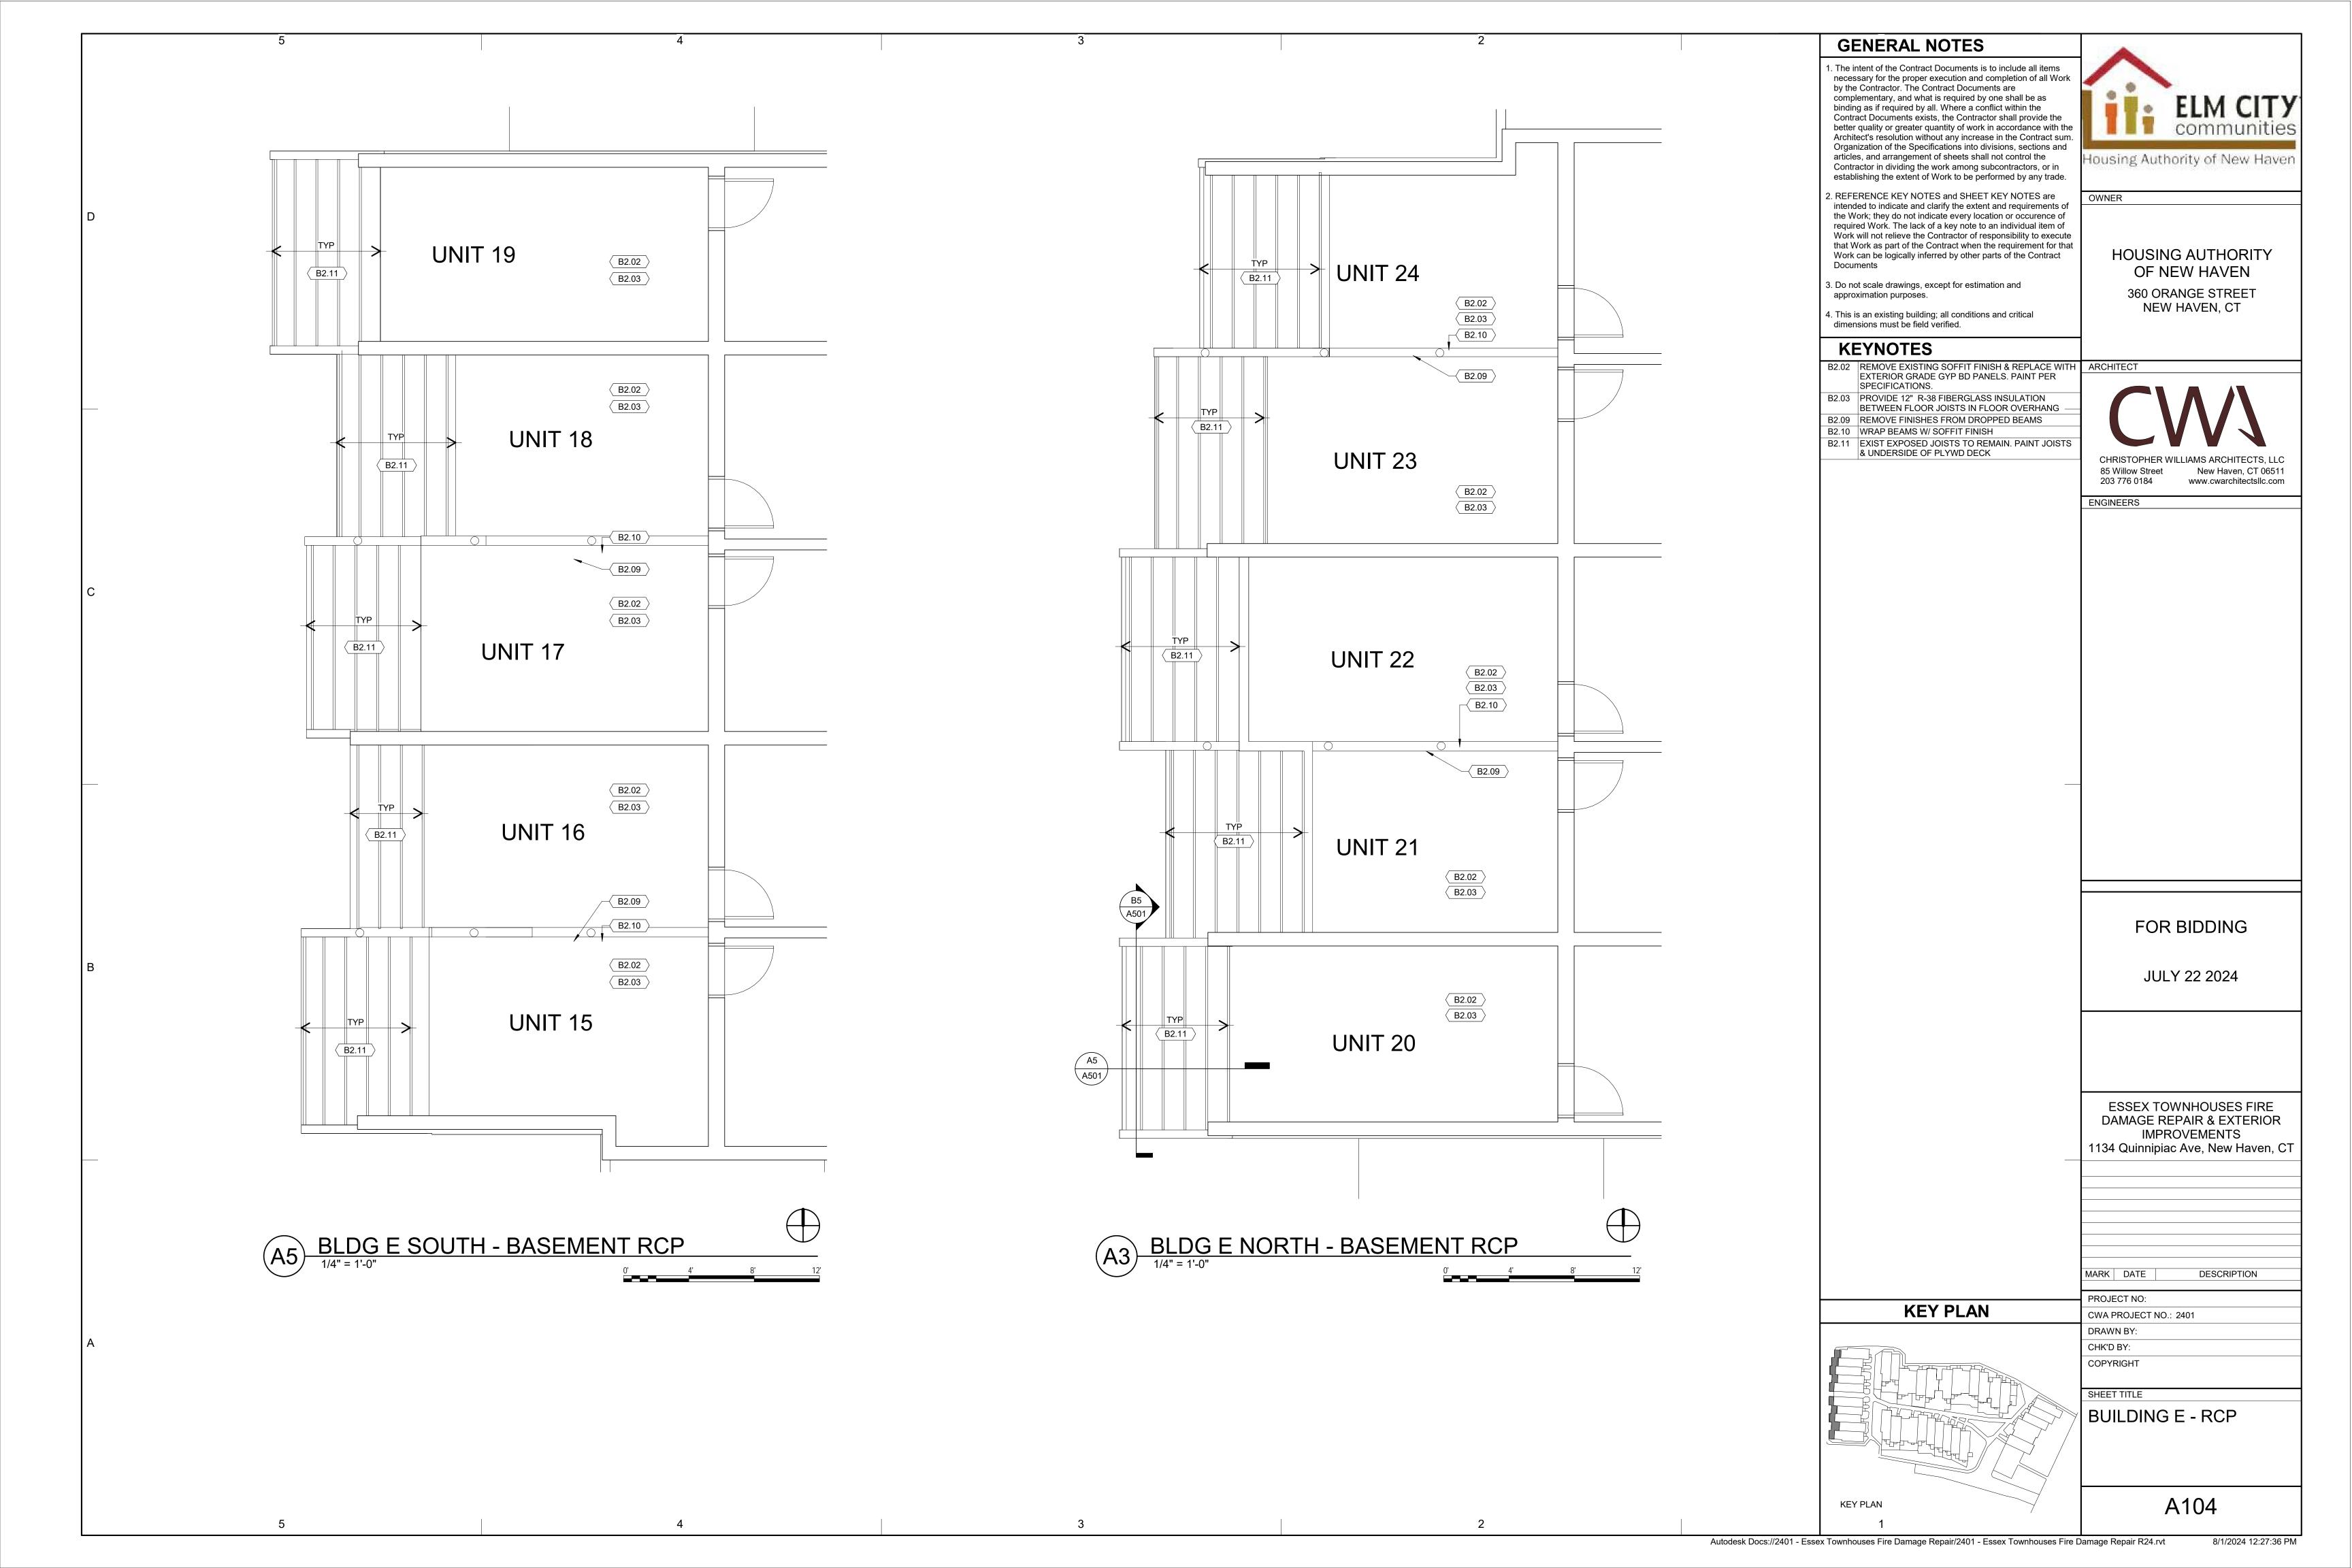


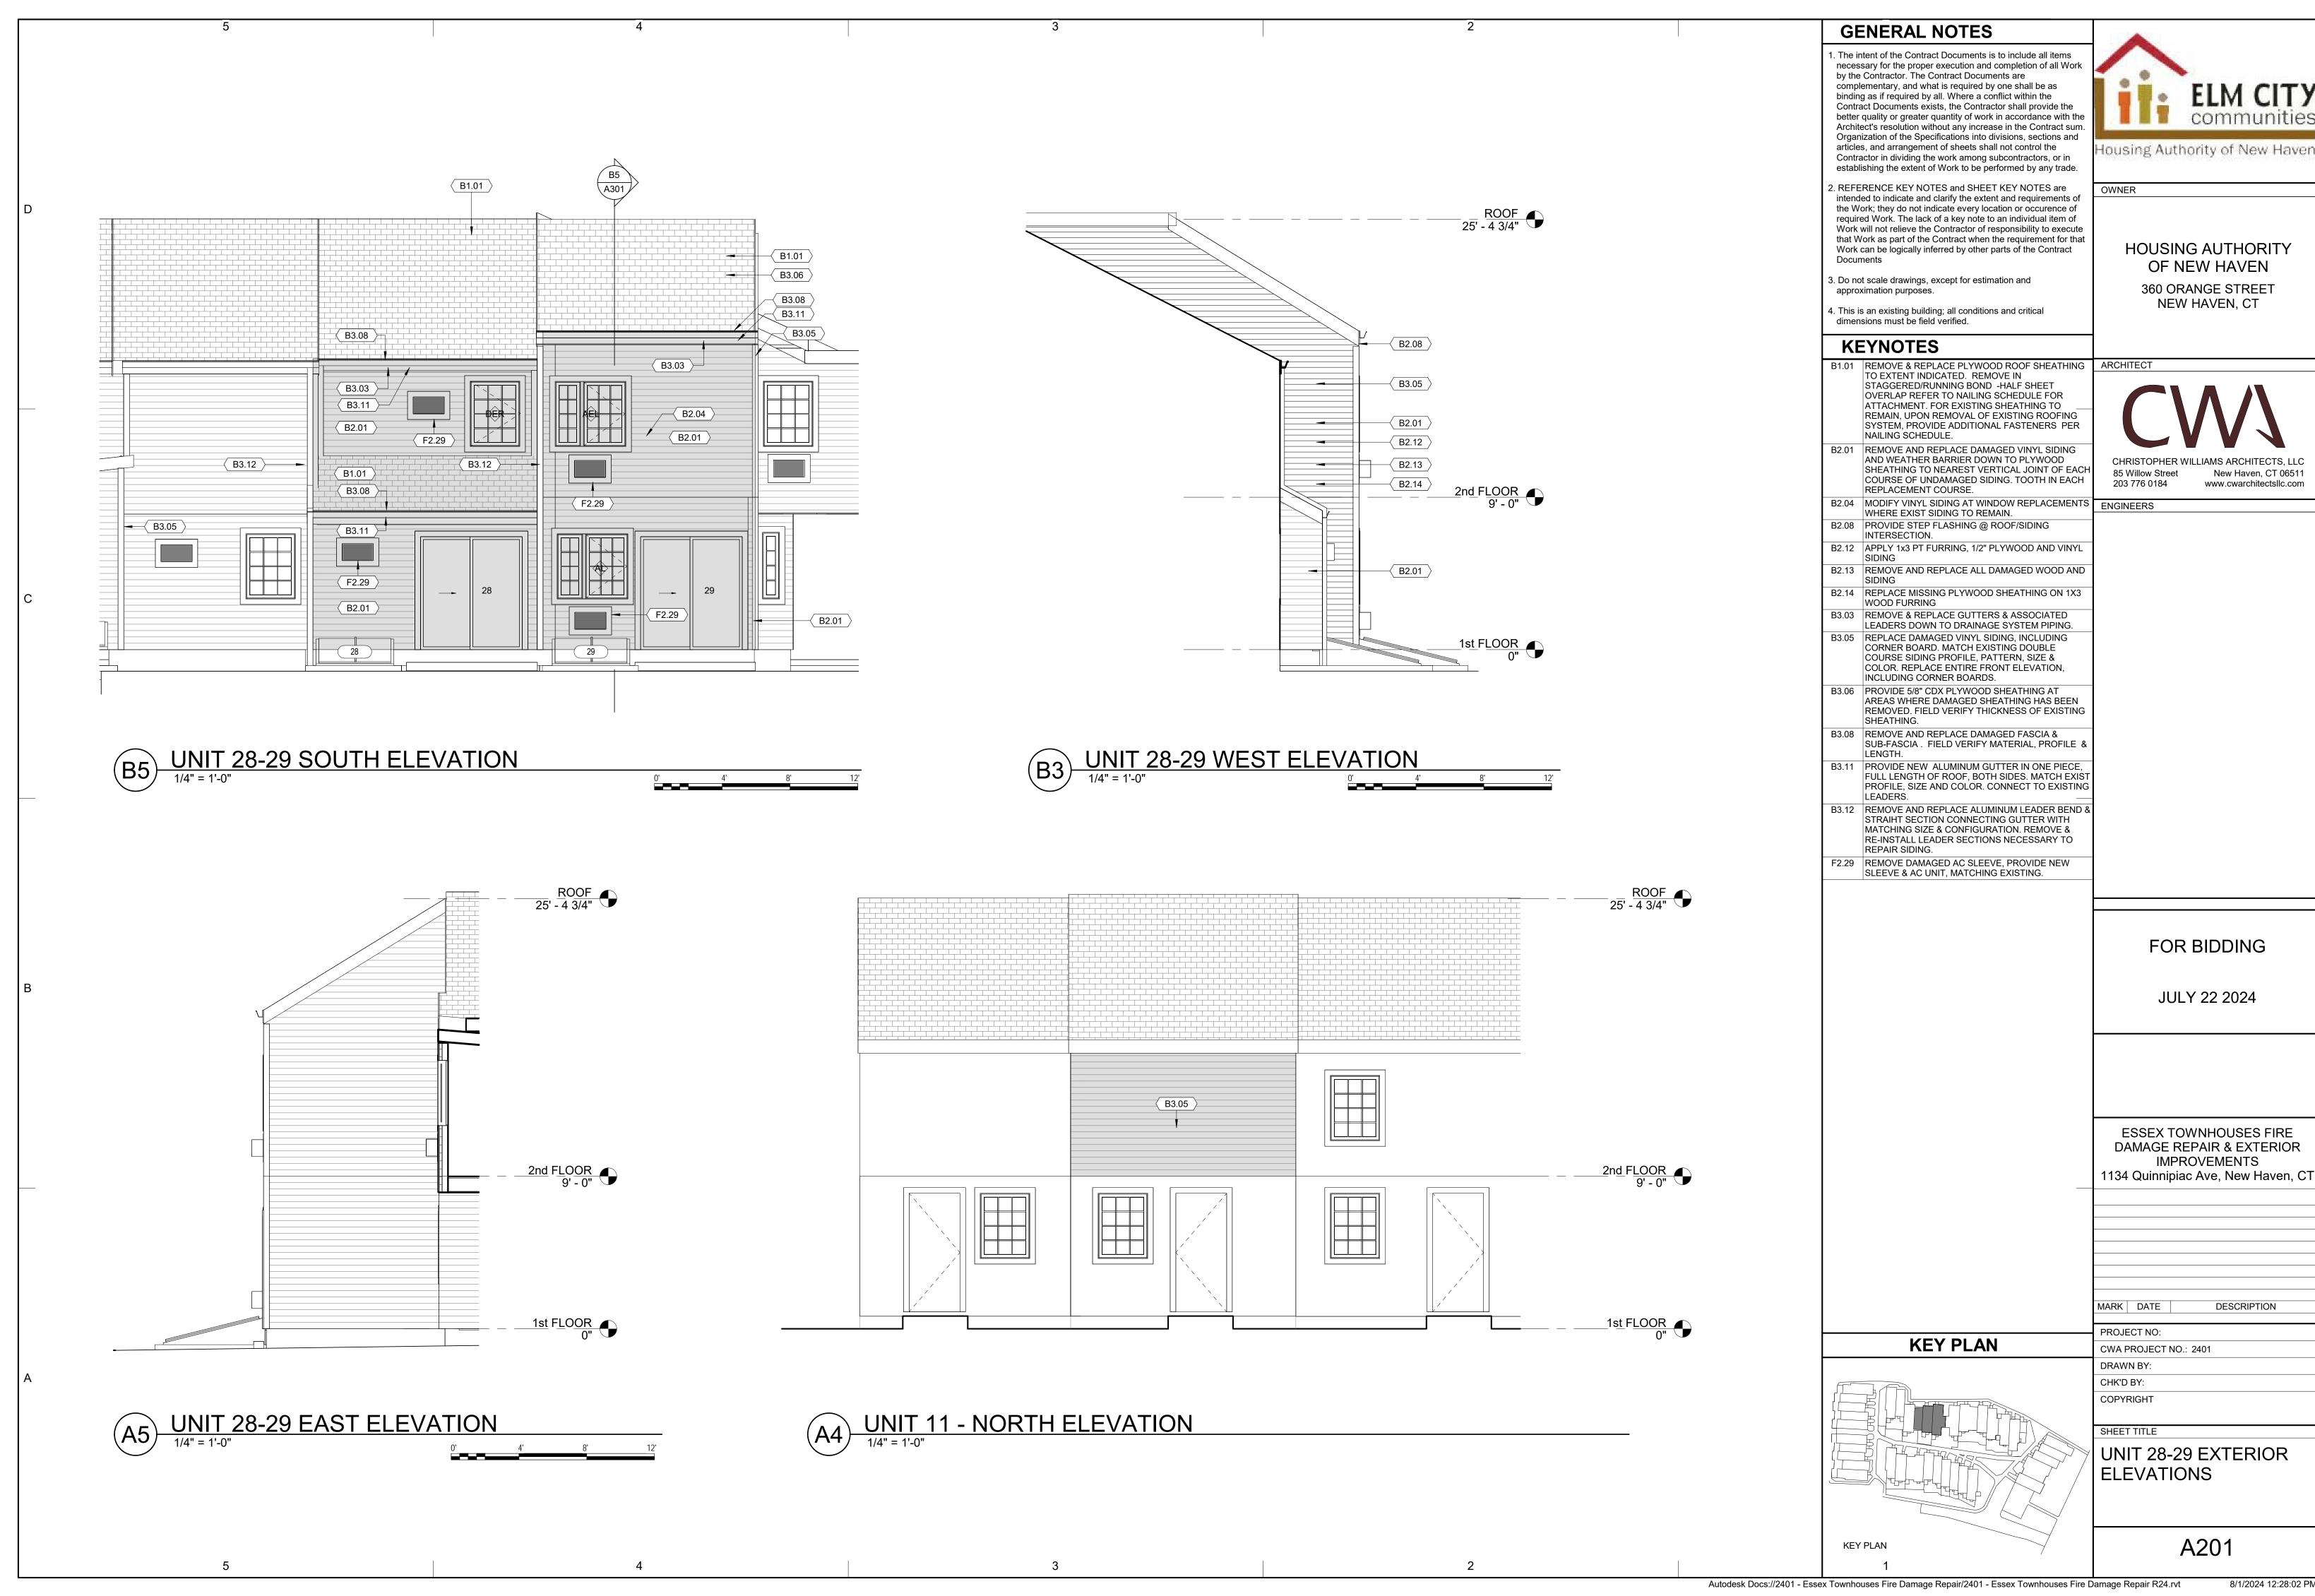


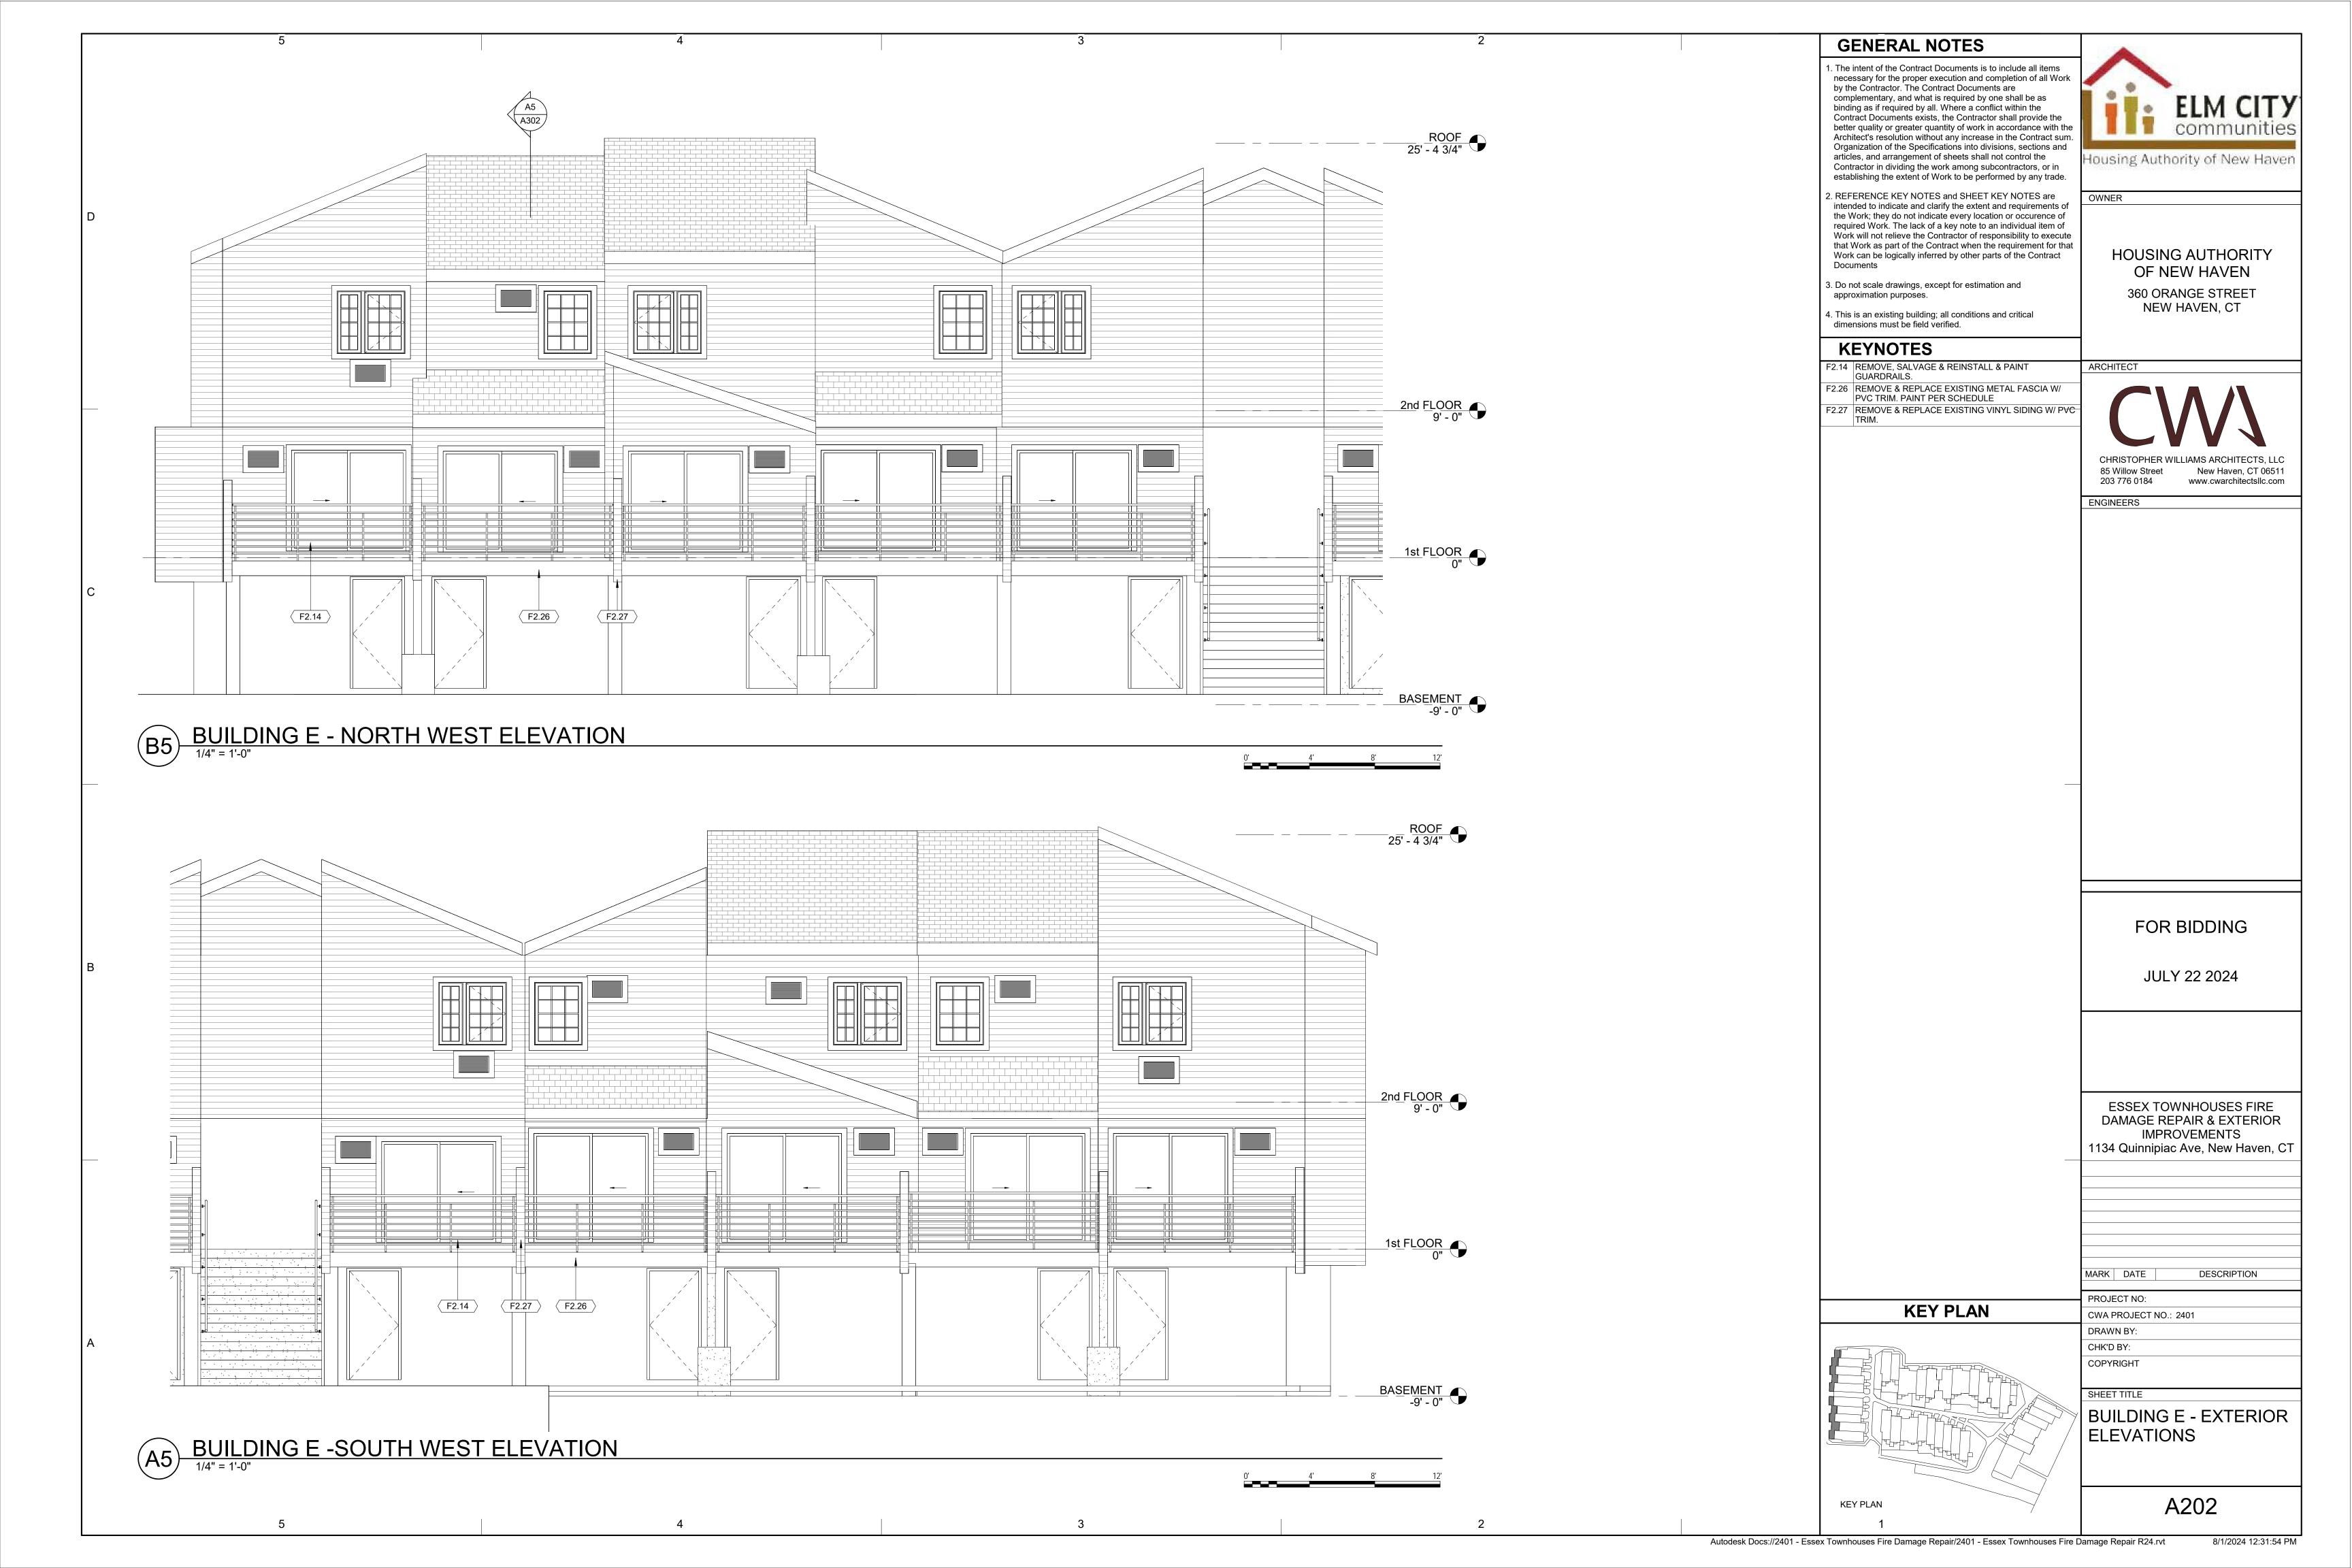

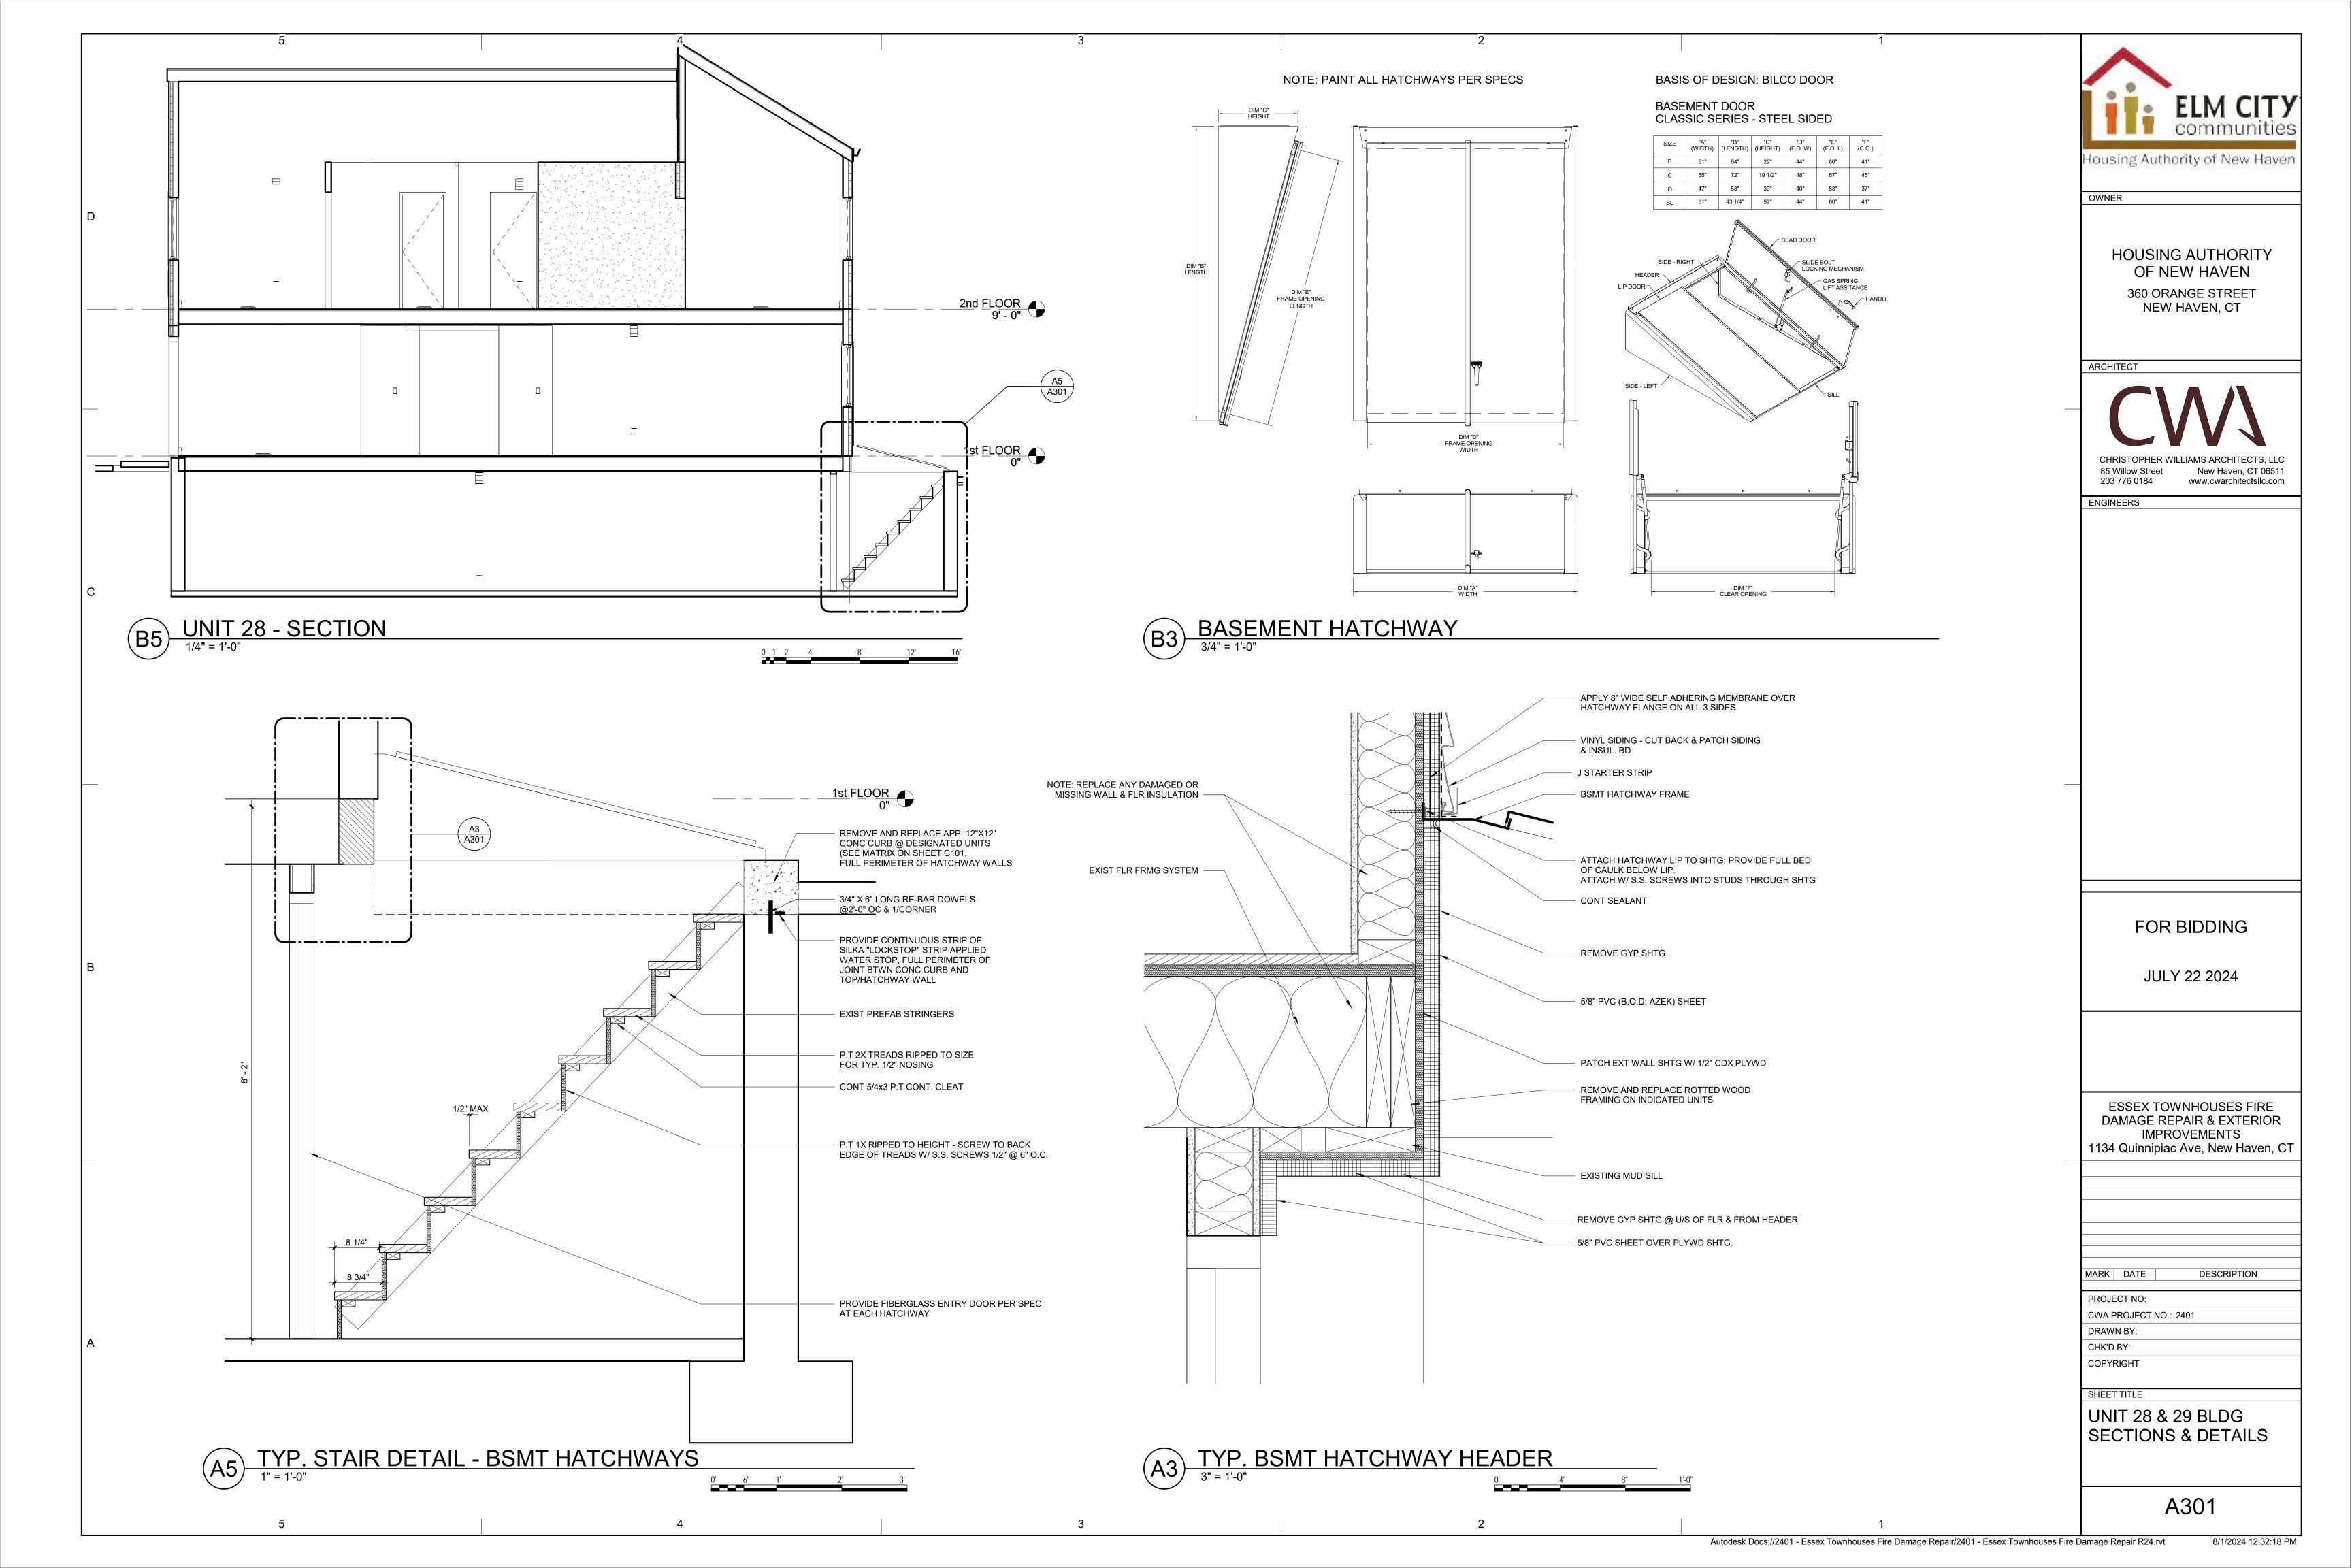

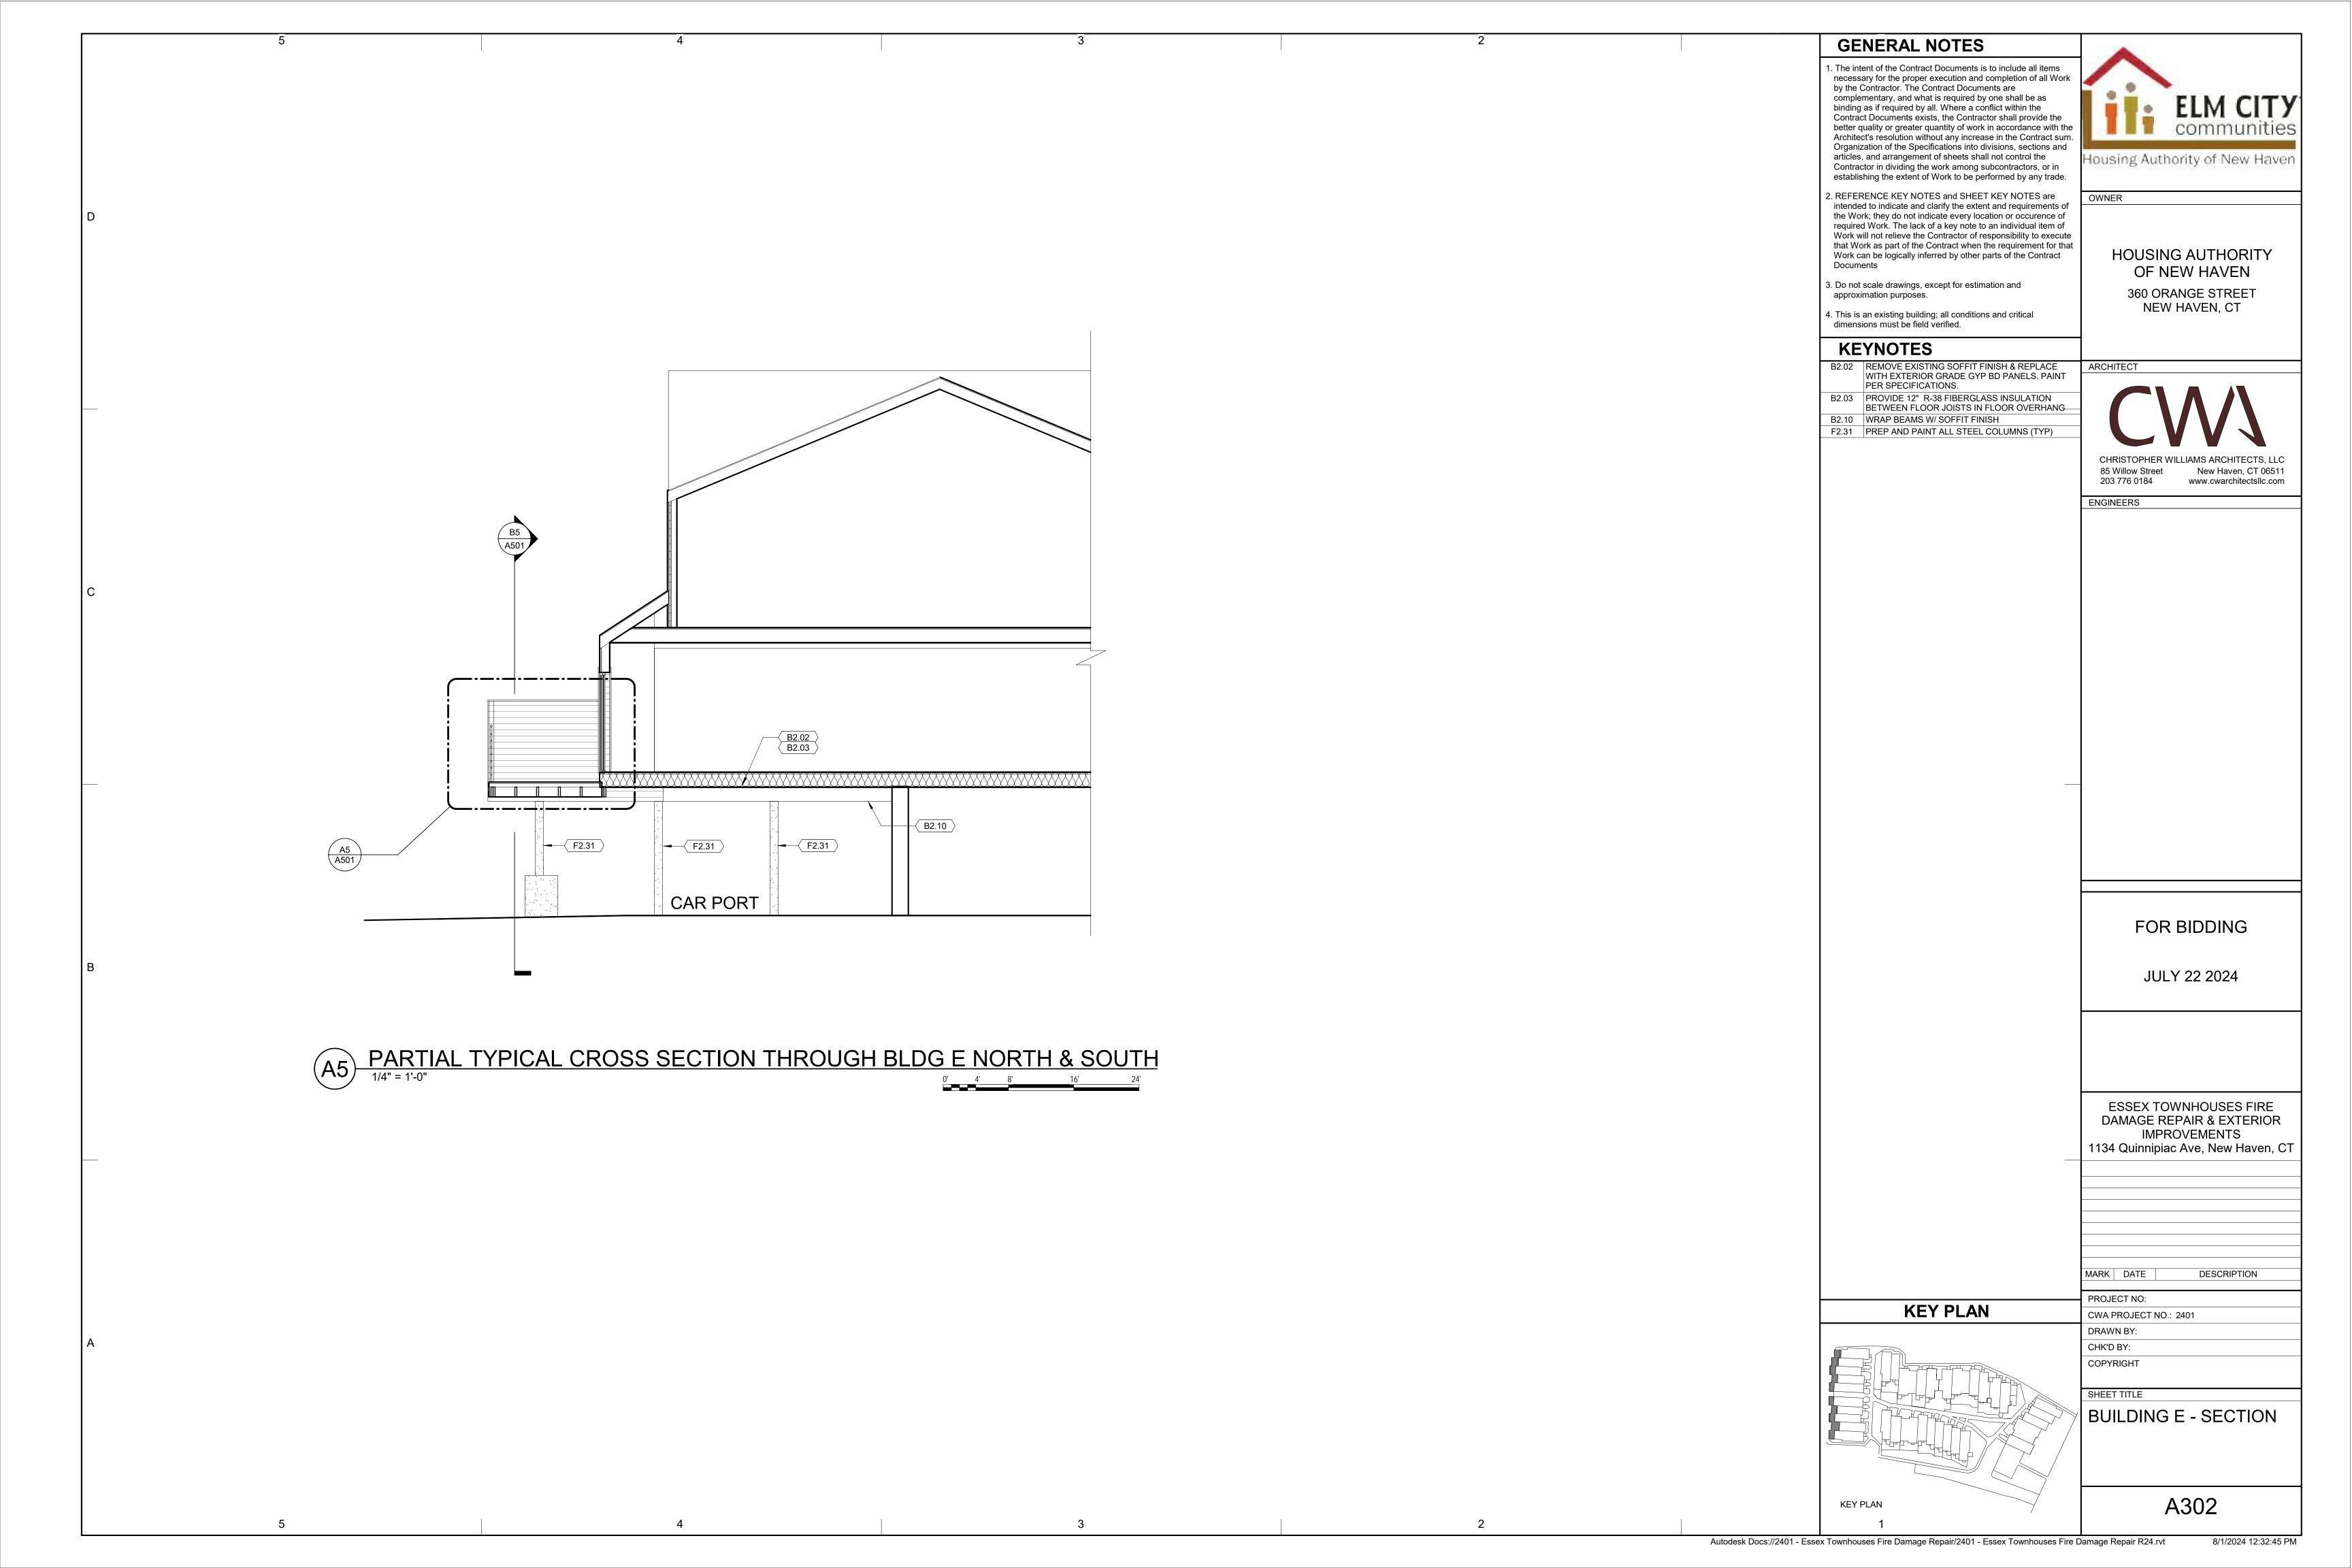


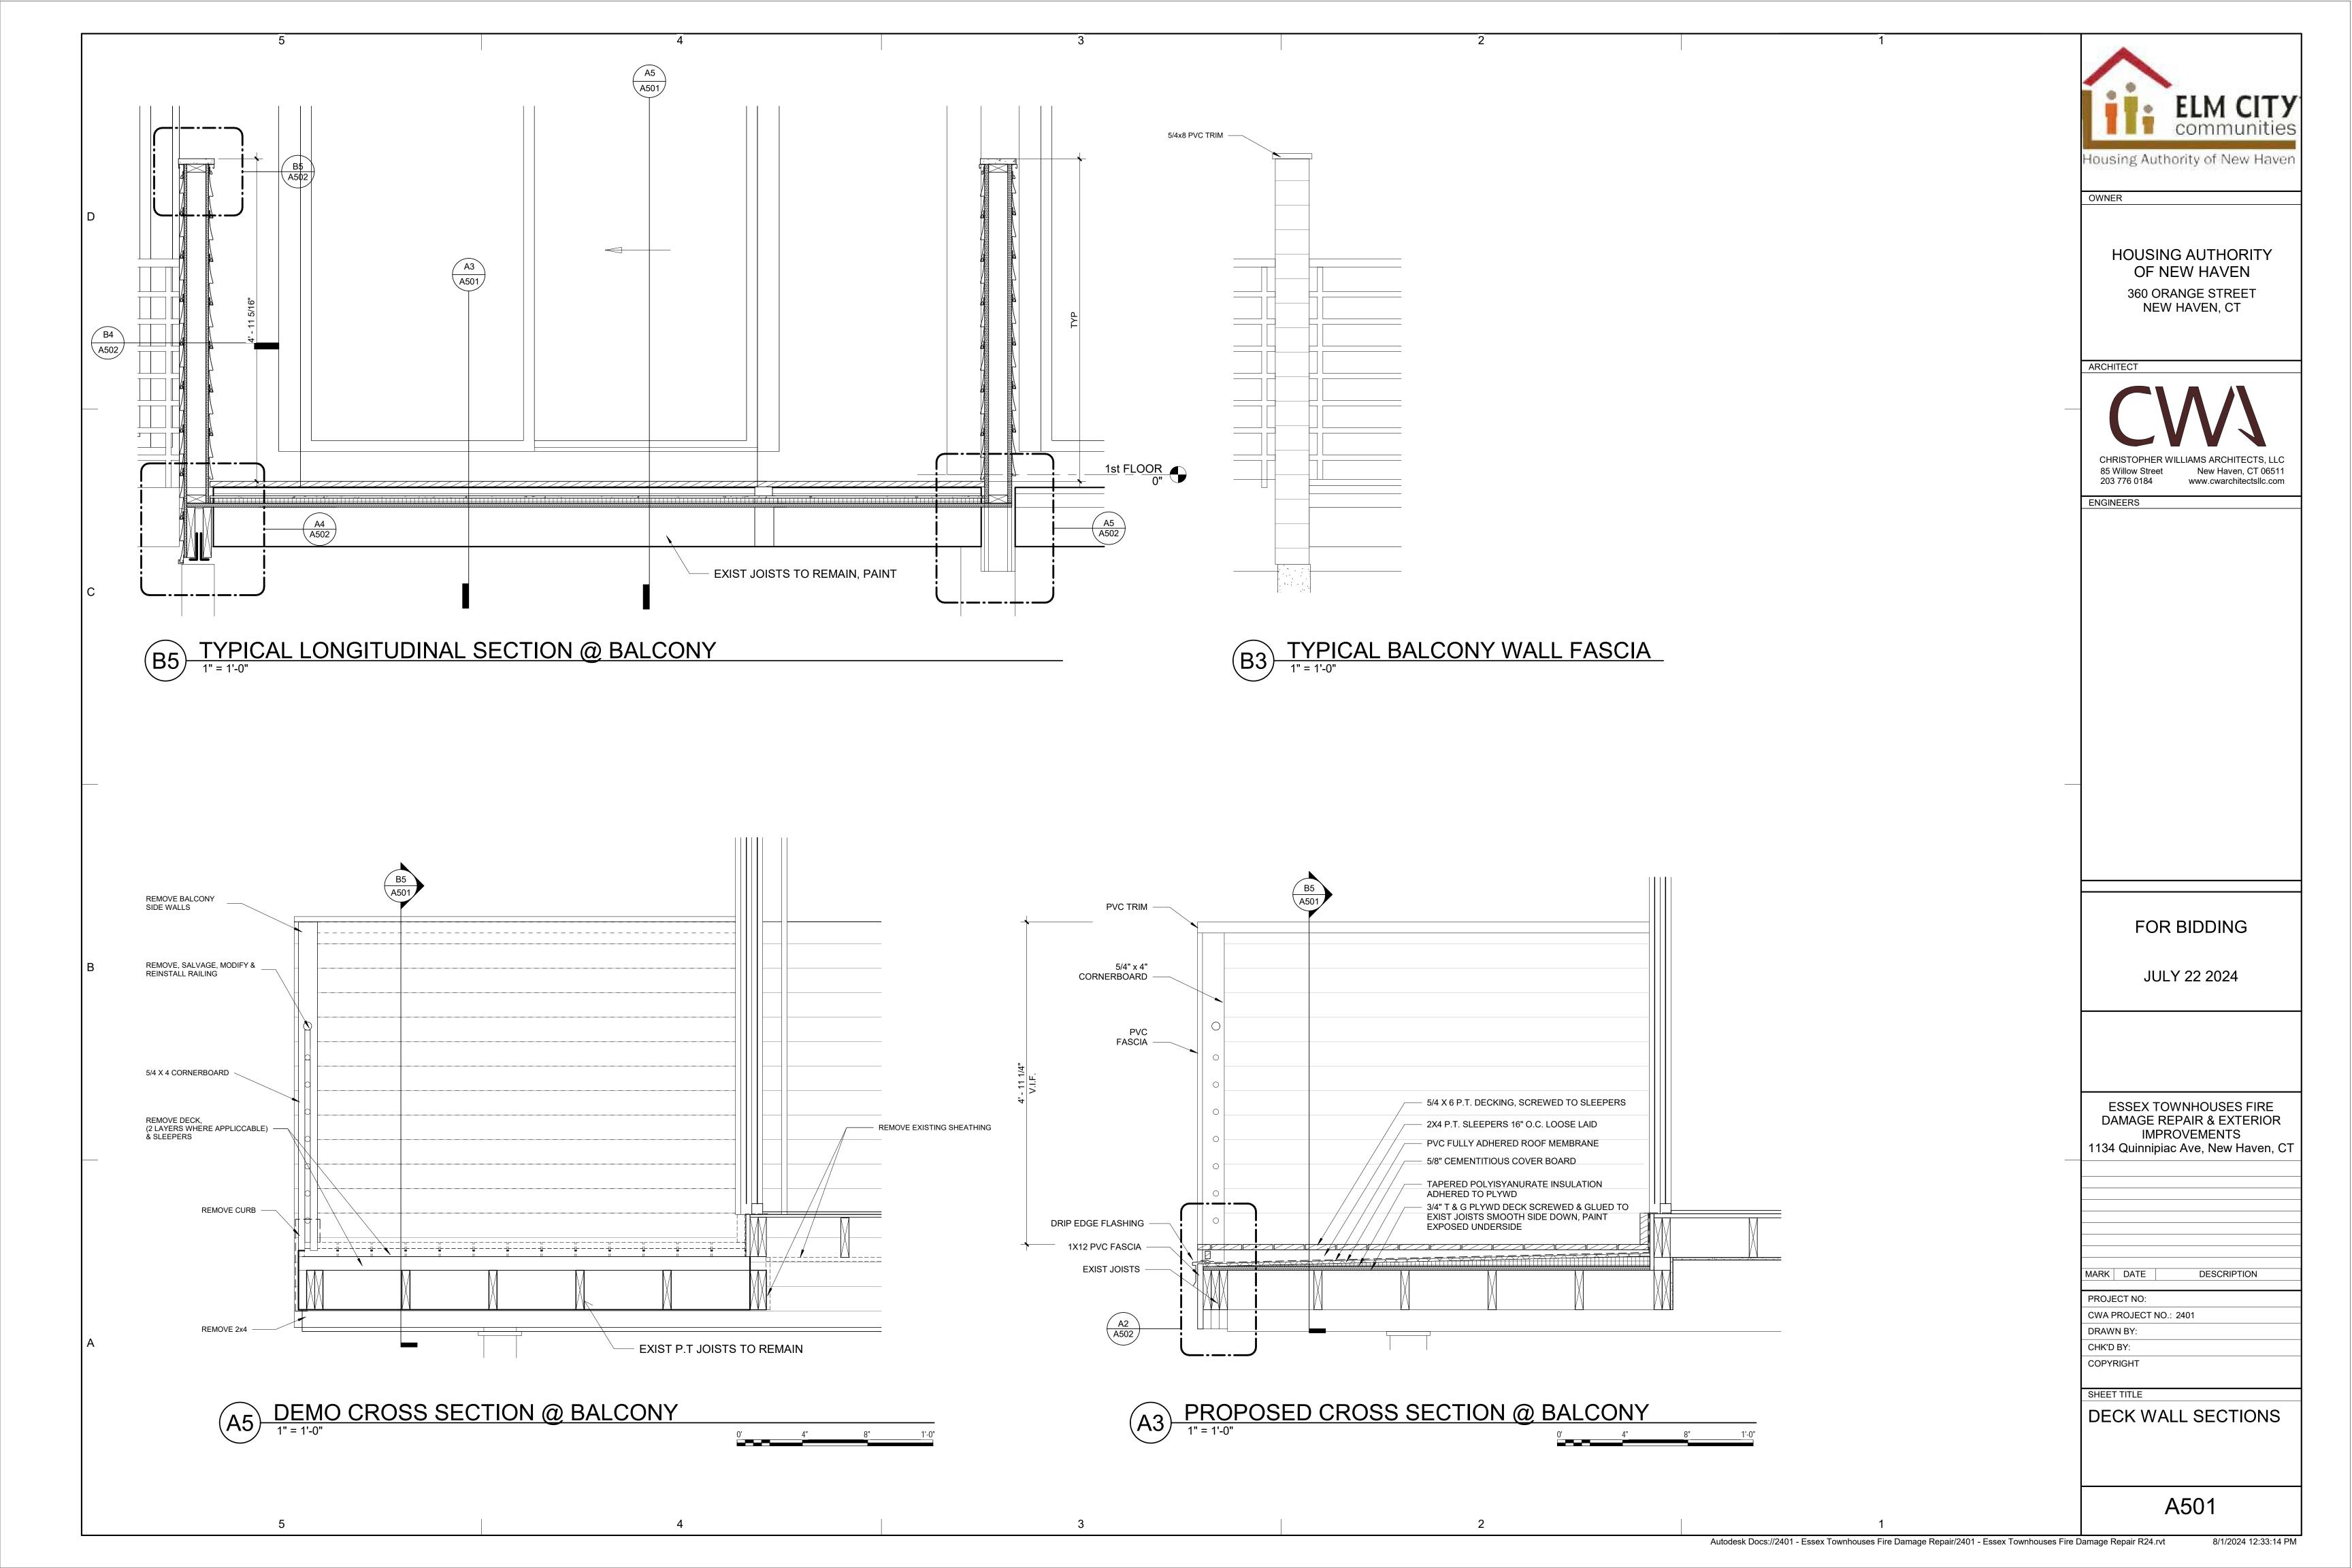


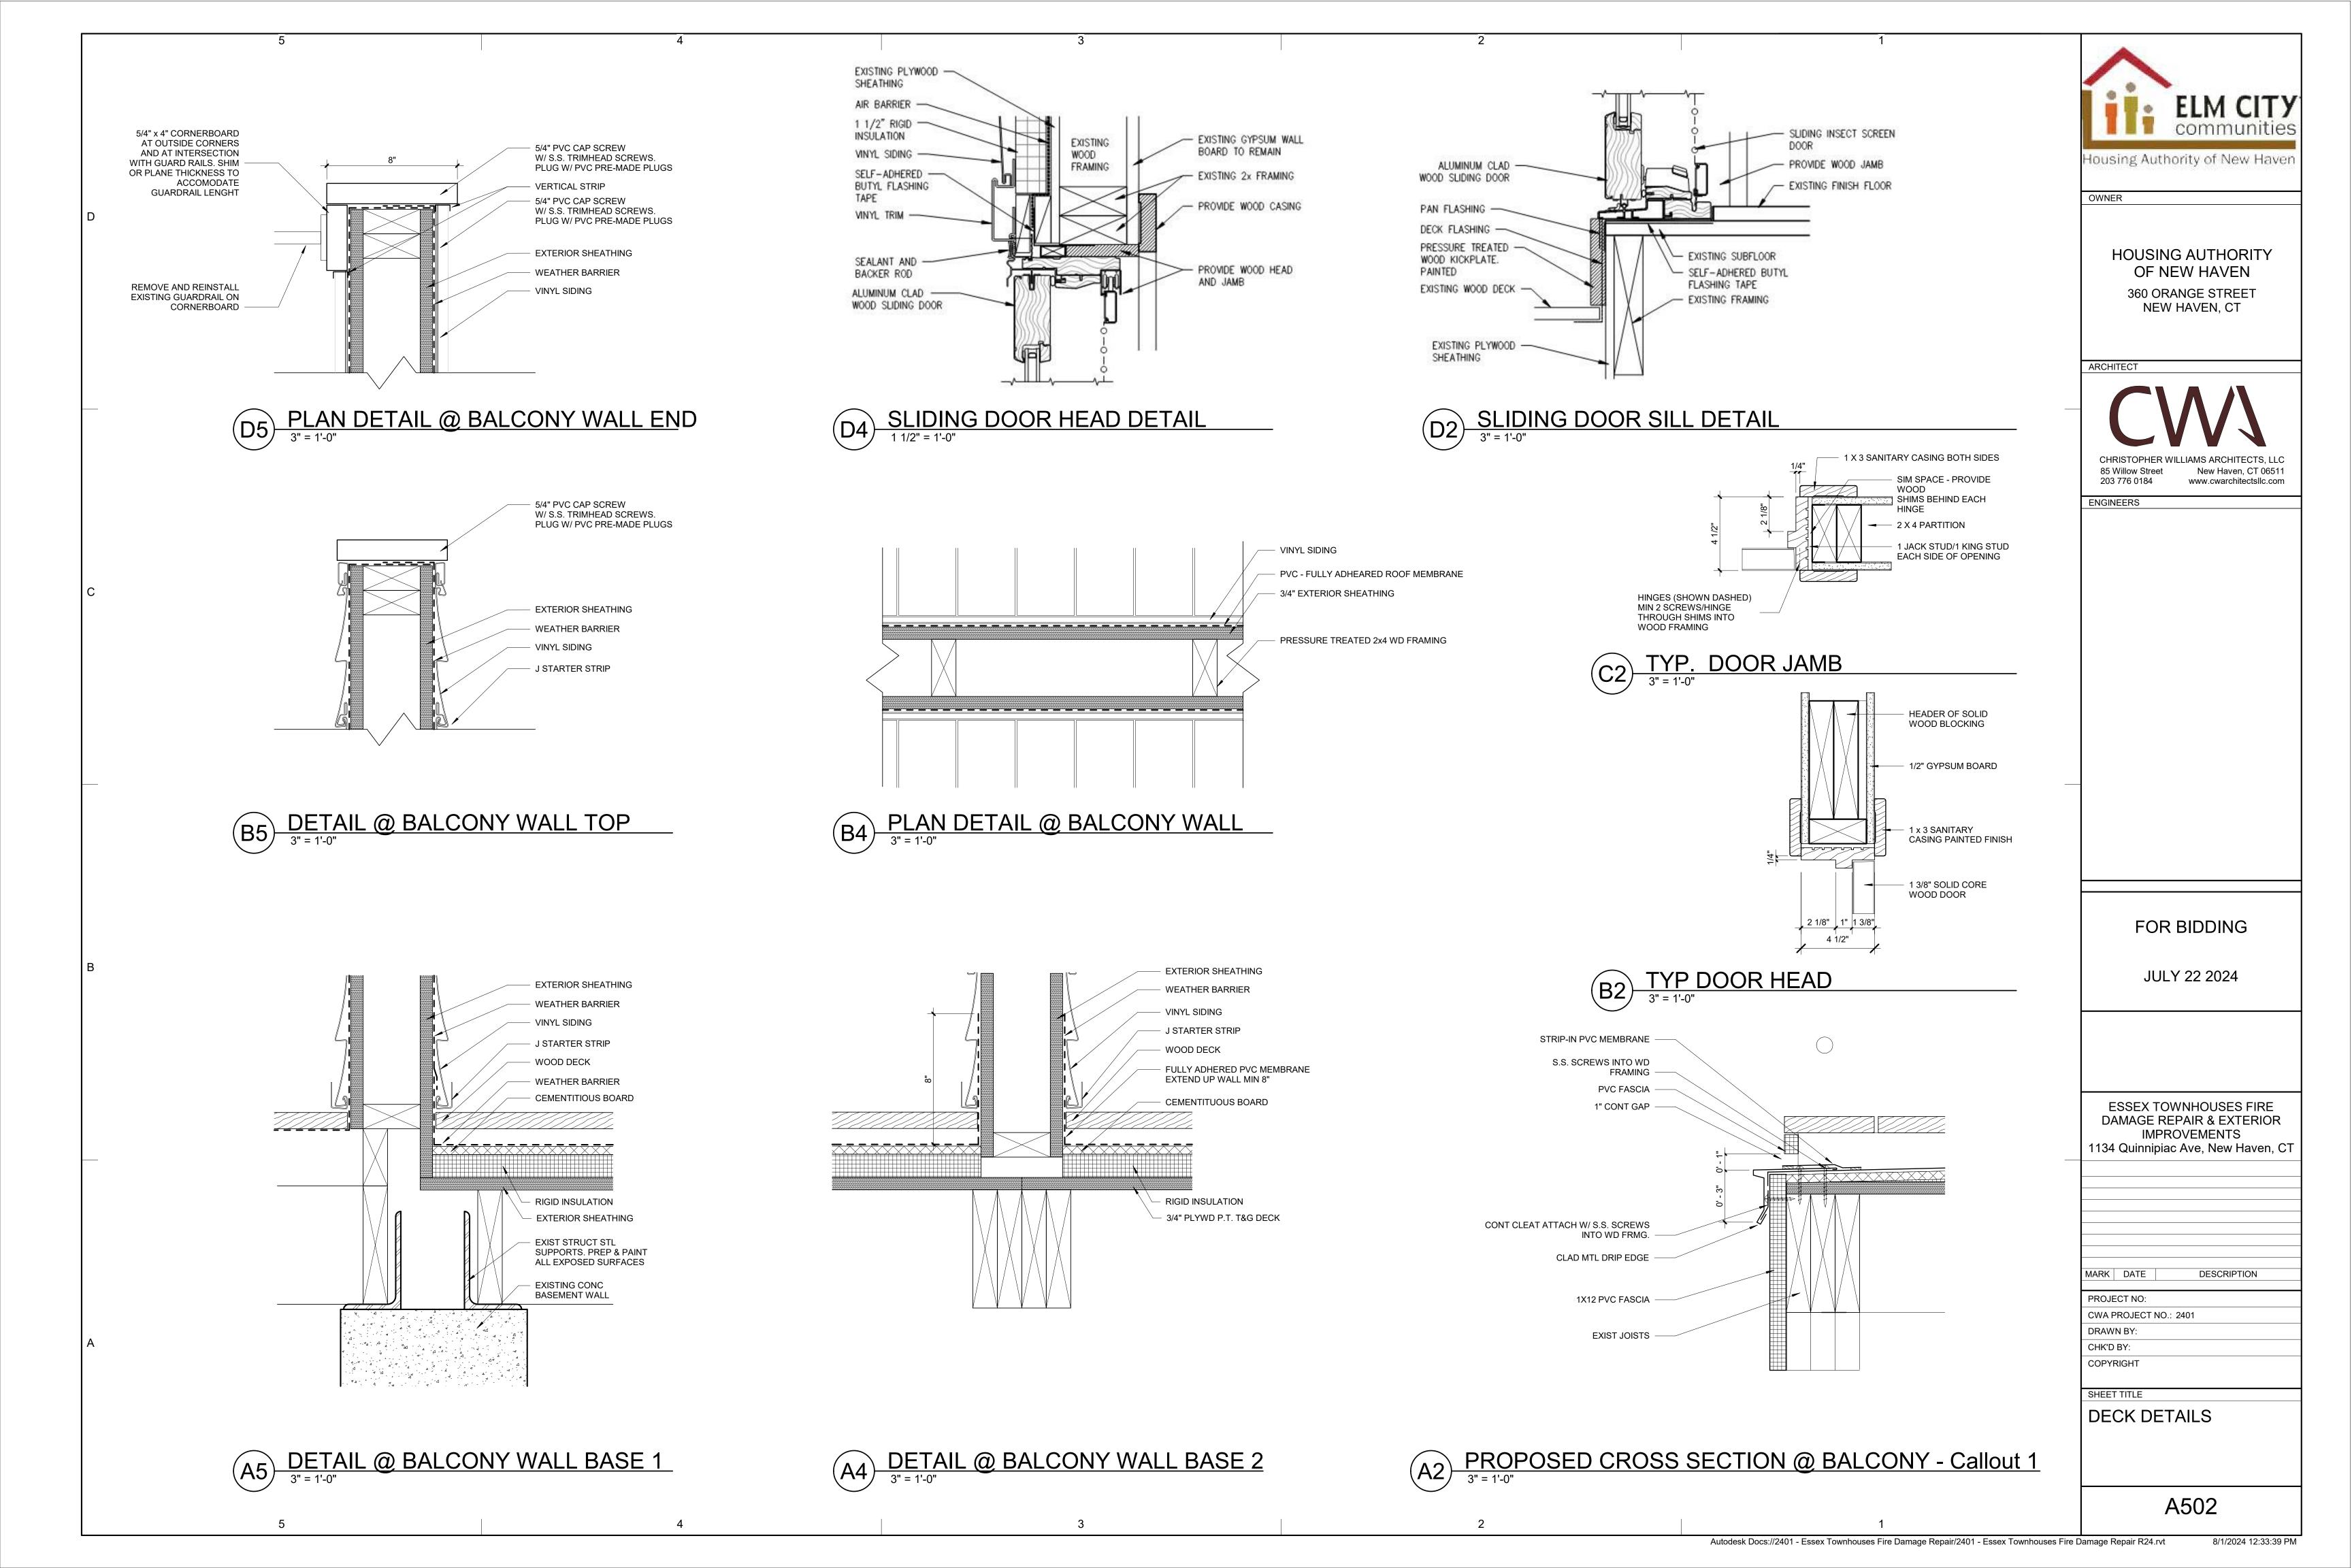

EXTERIOR FINISH SCHEDULE MANUFACTURER DESCRIPTION COLOR SCHEME VINYL HORIZONTAL SIDING CERTAINTEED CLASSIC DOUBLE 5" CLAPBOARD - #36122 COLOR 1B VYNIL CARPENTRY 3 1/2" LINEAL - #54706 VINYL WINDOW TRIM CERTAINTEED SNOW #31 WINDOW FRAME CLADDING ALUMINUM WINDOW CLADDING (OVER WINDOW FRAME) WHITE VINYL OUTSIDE CORNER POST CERTAINTEED VYNIL CARPENTRY 3/4" CORNERPOST - 3 1/3" X 3 1/3" FACE - MATTE - #51404 SNOW #31 COLOR 1A VINYL INSIDE CORNER POST CERTAINTEED VYNIL CARPENTRY 3/4" INSIDE CORNERPOST - MATTE - #51436 VINYL SOFFIT CERTAINTEED TRIPLE 4" FULLY VENTED UNIVERSAL SOFFIT - #48224 SNOW #31 FASCIA CLADDING ALUMINUM WINDOW CLADDING (OVER FASCIA BOARD) FACTORY APPLIED FINISH WHITE GUTTERS AND LEADER ALUMINUM GUTTERS WITH LEAD GUARD AND LEADERS WHITE RECTANFULAR GABLE VENT VERTICAL LOUVER - #FLV12X36 FACTORY FINISH (WHITE)

1. VERIFY ALL SIZES & COLORS IN FIELD AND WITH OWNER'S SUBMITTAL RECORDS FROM RECENTLY COMPLETED SIDING, ROOFING & WINDOW REPLACEMENT PROJECT.

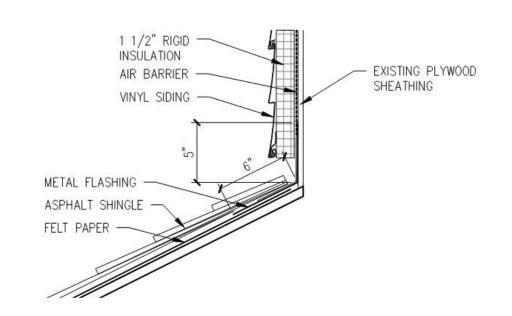

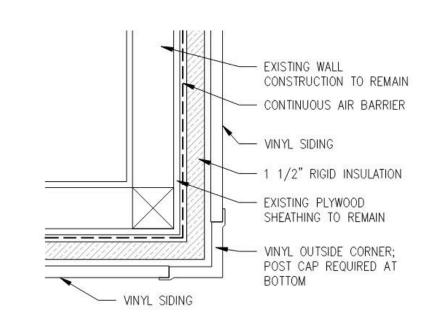


TYP WALL TO ROOF FLASHING DETAIL
1 1/2" = 1'-0"


- 1 1/2" RIGID

INSULATION



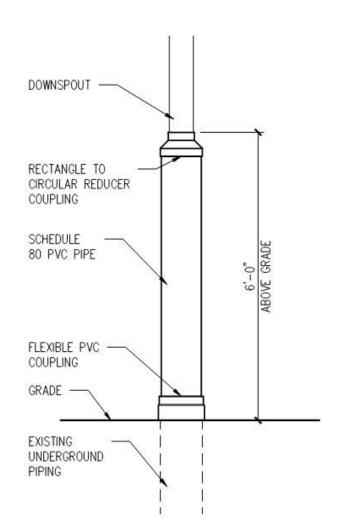

TYP LEADER CONNECTION DETAIL

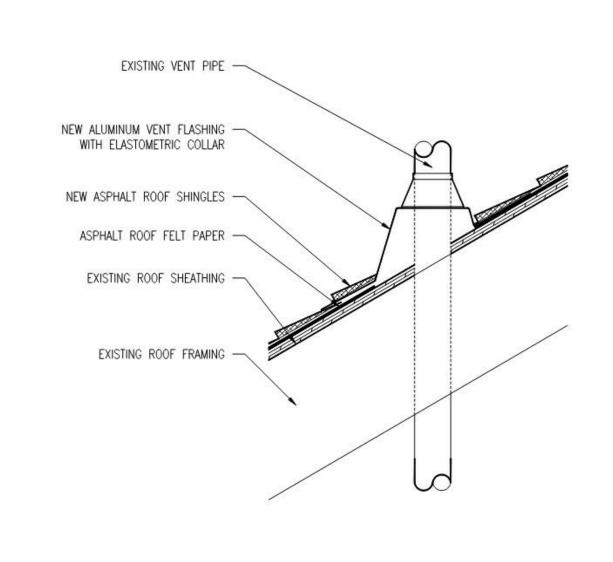

EXISTING PLYWOOD -SHEATHING TO REMAIN

DRIP EDGE -

2x8 PRESSURE TREATED WOOD WRAPPED IN

"J" CHANNEL -

1 1/2" RIGID -

CONTINUOUS AIR

PLYWOOD SHEATHING AS

TYP RAKE DETAIL


INSULATION

BARRIER


SELF-ADHERED BUTYL FLASHING TAPE

ALUMINUM


TYP VENT PIPE DETAIL

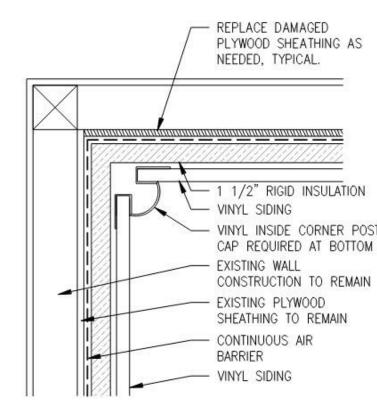

TYP INSIDE CORNER DETAIL
1 1/2" = 1'-0"

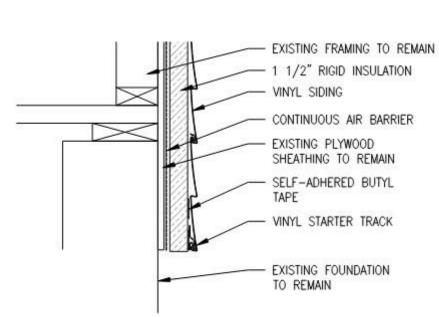

TYP SIDING BASE DETAIL

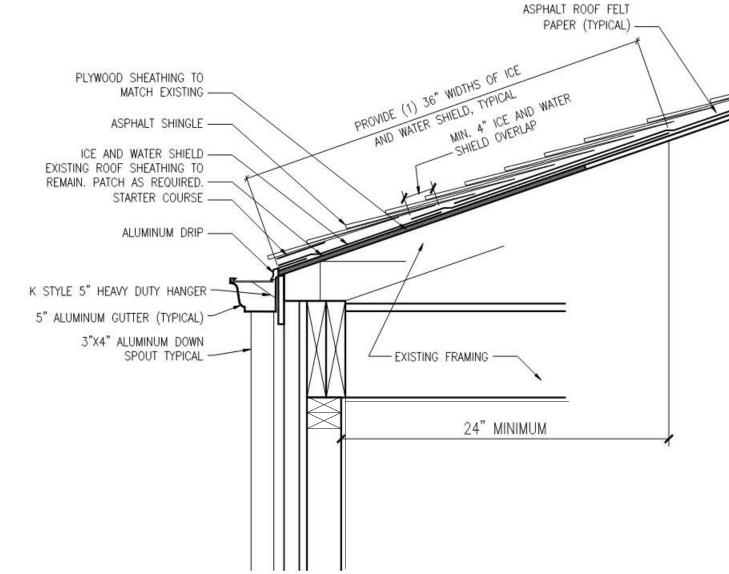

SIDING & ROOF DETAILS

Housing Authority of New Haver

HOUSING AUTHORITY

OF NEW HAVEN

360 ORANGE STREET

NEW HAVEN, CT

OWNER

ARCHITECT

A503

CWA PROJECT NO.: 2401

DRAWN BY:

COPYRIGHT

SHEET TITLE

New Haven, CT 06511 203 776 0184 www.cwarchitectsllc.com **ENGINEERS** FOR BIDDING JULY 22 2024 ASPHALT ROOF FELT **ESSEX TOWNHOUSES FIRE** DAMAGE REPAIR & EXTERIOR **IMPROVEMENTS** 1134 Quinnipiac Ave, New Haven, CT DESCRIPTION MARK DATE PROJECT NO:


ALUMINUM RIDGE ALUMINUM COIL ASPHALT SHINGLE - SEALANT AND SELF-ADHERED BUTYL FLASHING TAPE

EXISTING PLYWOOD

TYP RIDGE FLASHING DETAIL

Autodesk Docs://2401 - Essex Townhouses Fire Damage Repair/2401 - Essex Townhouses Fire Damage Repair R24.rvt


8/1/2024 12:34:01 PM

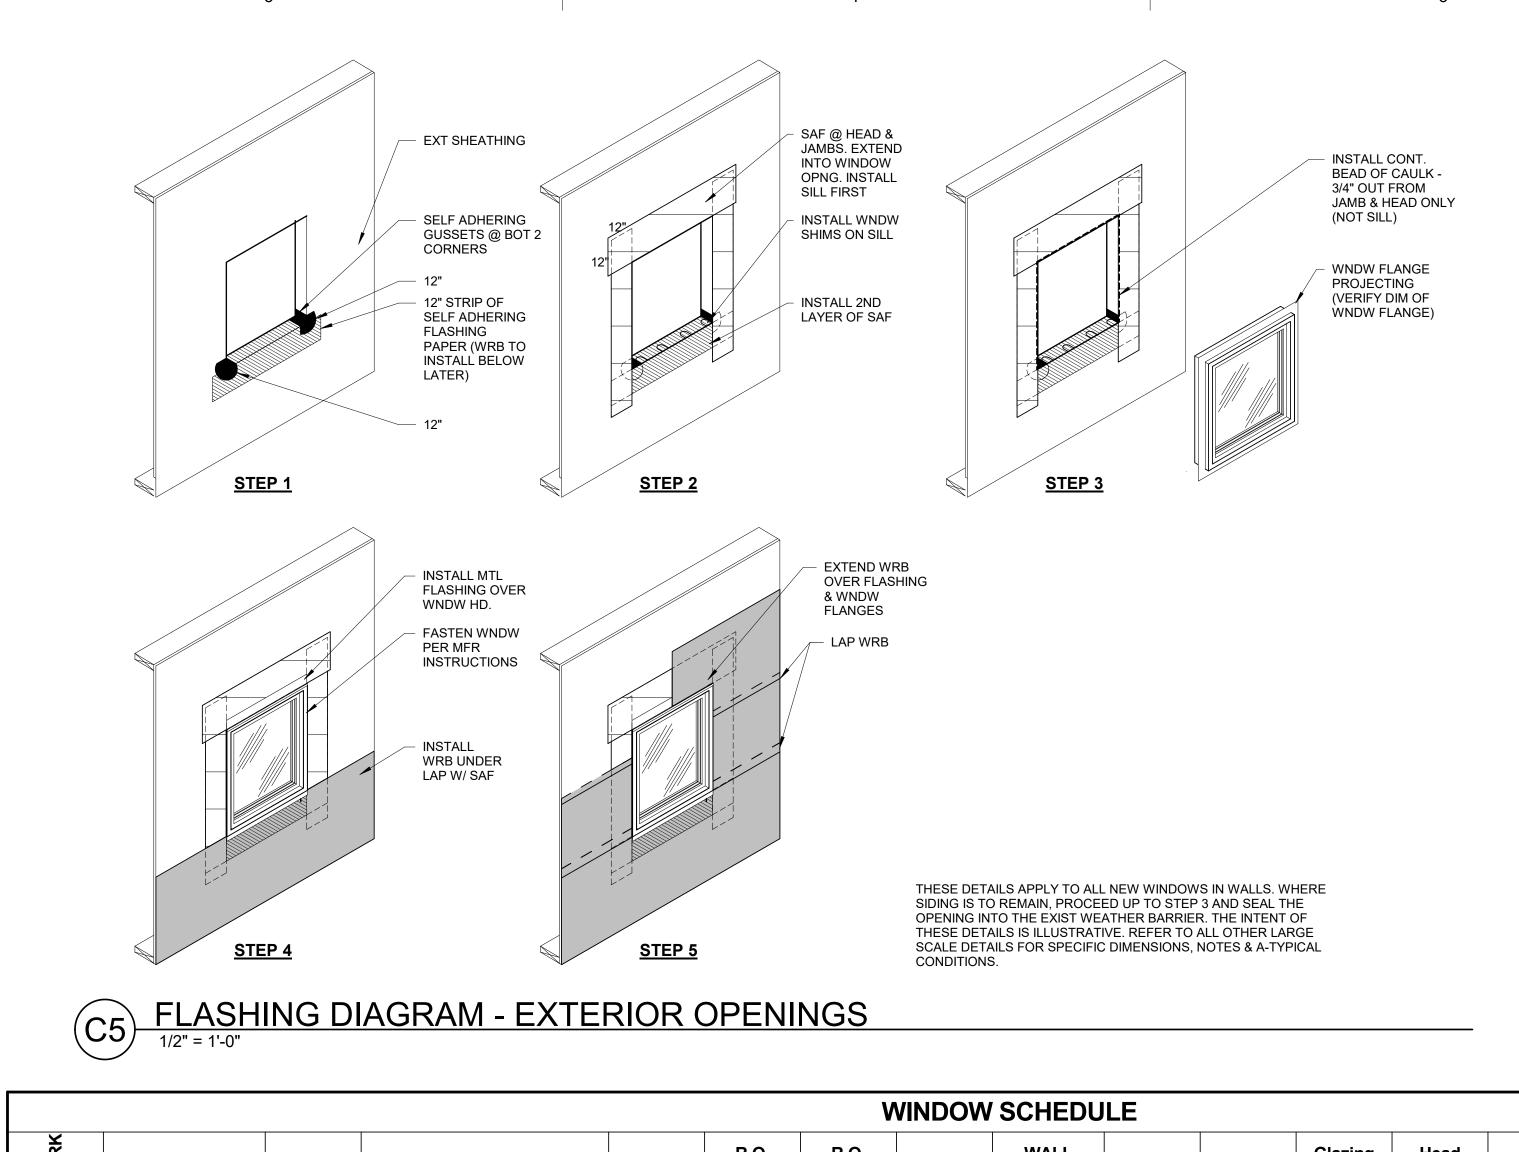

	WINDOW SCHEDULE												
MARK	MANUFACTURER	TYPE	Window Type	WIDTH	R.O. WIDTH	R.O. HEIGHT	HEIGHT	WALL THICKNESS EXTERIOR INTERIOR	Glazing (Windows)	Head Detail	Jamb Detail	Threshold Detail	Type Comments
AEL		3248 CSMT	Impervia Casement	50"	51"	46 1/2"	46"						
AL		3248 CSMT	Impervia Casement	50"	51"	46 1/2"	46"						
DER		3648 CSMT	Impervia Casement	35"	36"	46 5/8"	46 1/8"						

	A	PPLIANC	E SCHEDULE		
Mark	Description	Manufacturer	Model	QTY.	REMARKS
EQ-1	ELECTRIC RANGE - 30"	HOTPOINT	RBS360DMBB	2	
EQ-3	FRIGIDAIRE 16.3 CU. FT. TOP FREEZER	FRIGIDAIRE	FFHT1621TB	2	

	1							HEDU	JLE		T
		DOOR									
TYPE MARK	DOOR TYPE	SINGLE	DOUBLE	CASED OPENING	WIDTH	HEIGHT	THICKNESS	SOLID CORE WOOD P B B B B B B B B B B B B B B B B B B	PAINT		
										REMARKS	Coun
28	PELLA IMPERVIA 2 PANEL SLIDING PATIO DOOR		•		72"	80"	3/8"				1
29	PELLA IMPERVIA 2 PANEL SLIDING PATIO DOOR		•		72"	80"	1 3/4"				1
Α	SOLID CORE INTERIOR DOOR	•			36"	84"	1 3/4"	•	•	DOOR FRAMES TO REMAIN	1
В	SOLID CORE INTERIOR DOOR	•			28"	84"	1 3/4"	•	•	DOOR FRAMES TO REMAIN	1
С	SOLID CORE INTERIOR DOOR	•	<vari< td=""><td></td><td>30"</td><td>84"</td><td>1 3/4"</td><td>•</td><td>•</td><td>DOOR FRAMES TO REMAIN</td><td>6</td></vari<>		30"	84"	1 3/4"	•	•	DOOR FRAMES TO REMAIN	6
F	FIBERGLASS ENTRY DOOR	•			30"	84"	1 3/4"	•	•		21
G	MAGIC-GLIDE BI FOLD CLOSET DOORS		•		72"	80"	1 3/4"	•	•	DOOR FRAMES TO REMAIN	2

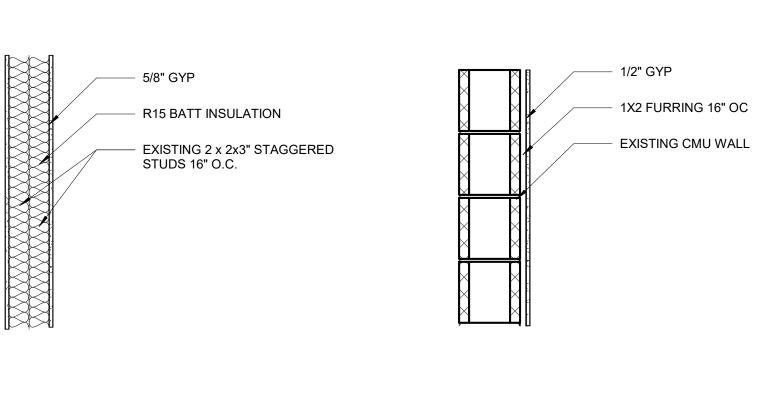







1x SOLID WD.
 FIXED SHELVES

PROVIDE 4 SHELVES,

STARTING @ 1'4" AFF

EVENLY SPACED,

FIXED SHELVES

1x4 CONTICLEAT

SHELVES, ATTACH

ALL 3 SIDES OF

TO STUDS

- 1x SOLID WD.

LINEN CLOS. SHELF DETAIL

1/2" = 1'-0"

1X12 SOUD WOOD FIXED

- BLOCKING BTWN STUDS @ EA. END

- INTERMEDIATE SHELF & POLE SUPPORT

CONTINUOUS 1X4 SOLID WOOD CLEAT ALL 3 SIDES 1X4 VERT BLOCKING BEHIND SUPPORT

- CLG FRMG (EXIST)

- DBLE 2X4 TOP PLATE

FIRE CAULK ALL PENETRATIONS THROUGH INTERIOR PARTITION BOTTOM & TOP PLATES

TREAT ALL FIRE DAMAGED WOOD TO REMAIN

SEALER/STAIN BLOCKER. THIS INCLUDES ALL WOOD FRAMING EXHIBITING SMOKE DAMAGE CONCEALED BY FINISHES & ABOVE THE CEILING

TREAT ALL WOOD SURFACES TO REMAIN EXHIBITING FUNGAL GROWTH WITH THE

FRMG & SHTG THAT WILL BE COVERED BY

SPECIFIED PRODUCT. THIS INCLUDES ALL WD

1/2" GYP BD WALLBOARD ON ALL INTERIOR &

EXTERIOR WALLS OF 2ND FLR & WHERE

FIRE CAULK ALL PENETRATIONS THROUGH INTERIOR PARTITION BOTTOM & TOP PLATES

EXIST/ NEW FLR FINISHES OVER PLYWD

INDICATED ON 1ST FLR

CONT 2X4 SHOE PLATE

FLR FRMG (EXIST)

WITH THE SPECIFIED SMOKE ODOR

EXPOSED IN THE ATTIC SPACE.

2X4 STUDS 16" OC

FINISHES

- CLOTHES POLE AS SPECIFIED

2X4 BLOCKING BTWN STUDS

CUT/PATCH GYP BD

@ MID-POINT

TYP CLOSET SHELF DETAIL

1/2" = 1'-0"

PARTITION TYPES ARE FOR REFERENCE FOR REPAIR & PARTIAL REPLACEMENT INFORMATION

Housing Authority of New Haver

HOUSING AUTHORITY OF NEW HAVEN 360 ORANGE STREET

NEW HAVEN, CT

ARCHITECT

New Haven, CT 06511

www.cwarchitectsllc.com

ENGINEERS

85 Willow Street

203 776 0184

OWNER

FOR BIDDING

JULY 22 2024

ESSEX TOWNHOUSES FIRE DAMAGE REPAIR & EXTERIOR **IMPROVEMENTS** 1134 Quinnipiac Ave, New Haven, CT

MARK DATE DESCRIPTION

PROJECT NO: CWA PROJECT NO.: 2401

DRAWN BY: CHK'D BY:

COPYRIGHT


SHEET TITLE

INTERIOR DETAILS

A504

Autodesk Docs://2401 - Essex Townhouses Fire Damage Repair/2401 - Essex Townhouses Fire Damage Repair R24.rvt

8/1/2024 12:34:23 PM

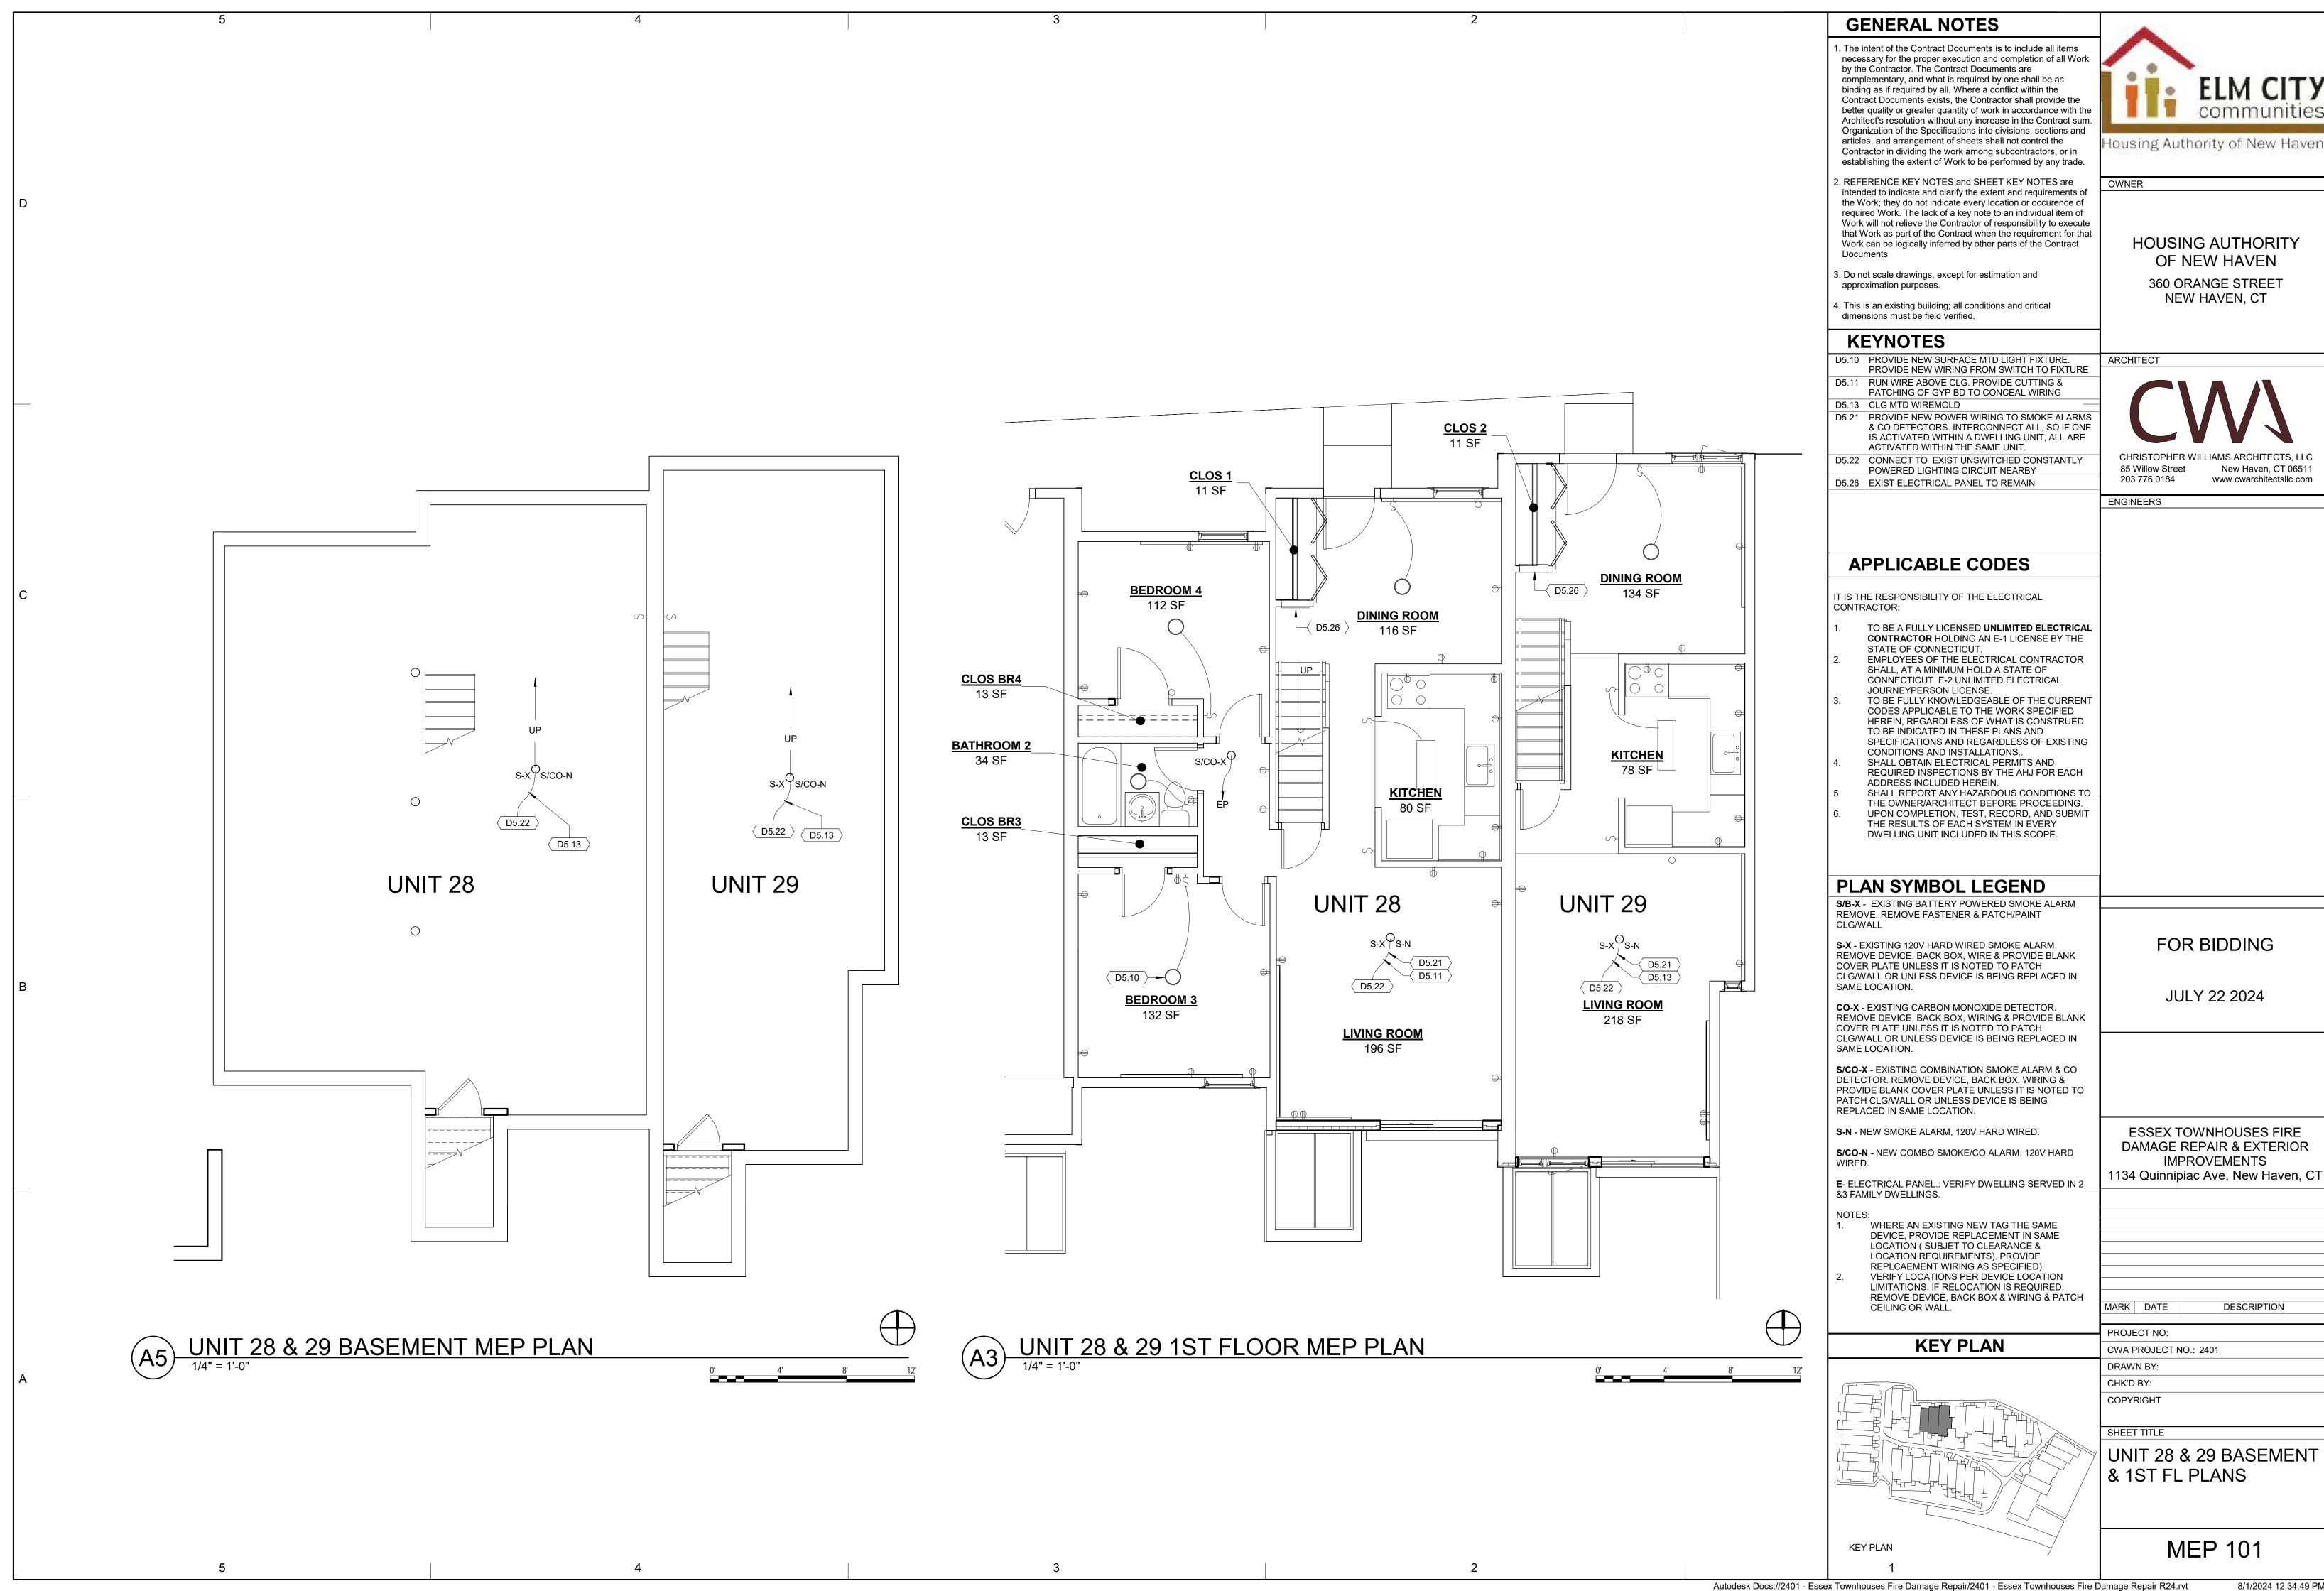

. The intent of the Contract Documents is to include all items necessary for the proper execution and completion of all Work by the Contractor. The Contract Documents are complementary, and what is required by one shall be as binding as if required by all. Where a conflict within the Contract Documents exists, the Contractor shall provide the better quality or greater quantity of work in accordance with the Architect's resolution without any increase in the Contract sum. Organization of the Specifications into divisions, sections and articles, and arrangement of sheets shall not control the Contractor in dividing the work among subcontractors, or in establishing the extent of Work to be performed by any trade. 2. REFERENCE KEY NOTES and SHEET KEY NOTES are intended to indicate and clarify the extent and requirements of the Work; they do not indicate every location or occurence of required Work. The lack of a key note to an individual item of Work will not relieve the Contractor of responsibility to execute that Work as part of the Contract when the requirement for that Work can be logically inferred by other parts of the Contract Documents 3. Do not scale drawings, except for estimation and approximation purposes. This is an existing building; all conditions and critical dimensions must be field verified. **KEYNOTES** D5.10 PROVIDE NEW SURFACE MTD LIGHT FIXTURE. PROVIDE NEW WIRING FROM SWITCH TO FIXTURE D5.11 RUN WIRE ABOVE CLG. PROVIDE CUTTING & PATCHING OF GYP BD TO CONCEAL WIRING D5.21 PROVIDE NEW POWER WIRING TO SMOKE ALARMS & CO DETECTORS. INTERCONNECT ALL, SO IF ONE IS ACTIVATED WITHIN A DWELLING UNIT, ALL ARE ACTIVATED WITHIN THE SAME UNIT. D5.22 CONNECT TO EXIST UNSWITCHED CONSTANTLY POWERED LIGHTING CIRCUIT NEARBY **ENGINEERS** BEDROOM 3 **BEDROOM 2** 139 SF **APPLICABLE CODES** 136 SF (D5.21) IT IS THE RESPONSIBILITY OF THE ELECTRICAL CONTRACTOR: **CLOSET BR3** TO BE A FULLY LICENSED UNLIMITED ELECTRICAL CONTRACTOR HOLDING AN E-1 LICENSE BY THE 18 SF STATE OF CONNECTICUT. S-N CLOSET BR2 EMPLOYEES OF THE ELECTRICAL CONTRACTOR SHALL, AT A MINIMUM HOLD A STATE OF CONNECTICUT E-2 UNLIMITED ELECTRICAL **BATHROOM 1** JOURNEYPERSON LICENSE. TO BE FULLY KNOWLEDGEABLE OF THE CURRENT 43 SF CODES APPLICABLE TO THE WORK SPECIFIED HEREIN, REGARDLESS OF WHAT IS CONSTRUED TO BE INDICATED IN THESE PLANS AND SPECIFICATIONS AND REGARDLESS OF EXISTING CONDITIONS AND INSTALLATIONS.. SHALL OBTAIN ELECTRICAL PERMITS AND **BATHROOM 1** REQUIRED INSPECTIONS BY THE AHJ FOR EACH s/co-x ∜s/¢ŏ-n 24 SF ADDRESS INCLUDED HEREIN. SHALL REPORT ANY HAZARDOUS CONDITIONS TO **HALLWAY** THE OWNER/ARCHITECT BEFORE PROCEEDING. **CLOSET BR2** UPON COMPLETION, TEST, RECORD, AND SUBMIT **HALLWAY** 52 SF 12 SF THE RESULTS OF EACH SYSTEM IN EVERY 54 SF DWELLING UNIT INCLUDED IN THIS SCOPE. NIS **BEDROOM 2** s/co-x s/co-N (D5.11 125 SF PLAN SYMBOL LEGEND S/B-X - EXISTING BATTERY POWERED SMOKE ALARM REMOVE. REMOVE FASTENER & PATCH/PAINT **UNIT 29** CLG/WALL **CLOSET BR1** (D5.22) S-X - EXISTING 120V HARD WIRED SMOKE ALARM. 16 SF REMOVE DEVICE, BACK BOX, WIRE & PROVIDE BLANK BEDROOM 1 COVER PLATE UNLESS IT IS NOTED TO PATCH CLG/WALL OR UNLESS DEVICE IS BEING REPLACED IN ─**√** D5.10 **CLOSET BR1** 117 SF SAME LOCATION. **CO-X** - EXISTING CARBON MONOXIDE DETECTOR. UNIT 28 REMOVE DEVICE, BACK BOX, WIRING & PROVIDE BLANK COVER PLATE UNLESS IT IS NOTED TO PATCH CLG/WALL OR UNLESS DEVICE IS BEING REPLACED IN $\circ_{\mathsf{S-N}}$ SAME LOCATION. **S/CO-X** - EXISTING COMBINATION SMOKE ALARM & CO DETECTOR. REMOVE DEVICE, BACK BOX, WIRING & D5.10 PROVIDE BLANK COVER PLATE UNLESS IT IS NOTED TO PATCH CLG/WALL OR UNLESS DEVICE IS BEING REPLACED IN SAME LOCATION. **BEDROOM 1 ESSEX TOWNHOUSES FIRE** S-N - NEW SMOKE ALARM, 120V HARD WIRED. 119 SF DAMAGE REPAIR & EXTERIOR S/CO-N - NEW COMBO SMOKE/CO ALARM, 120V HARD 1134 Quinnipiac Ave, New Haven, CT E- ELECTRICAL PANEL.: VERIFY DWELLING SERVED IN 2_ &3 FAMILY DWELLINGS. 13' - 0 1/4" NOTES: 1. WHERE AN EXISTING NEW TAG THE SAME DEVICE, PROVIDE REPLACEMENT IN SAME LOCATION (SUBJET TO CLEARANCE & LOCATION REQUIREMENTS). PROVIDE REPLCAEMENT WIRING AS SPECIFIED). VERIFY LOCATIONS PER DEVICE LOCATION LIMITATIONS. IF RELOCATION IS REQUIRED; REMOVE DEVICE, BACK BOX & WIRING & PATCH MARK DATE CEILING OR WALL. (A5) UNIT 28 & 29 2ND FLOOR PLAN **KEY PLAN** DRAWN BY: CHK'D BY: COPYRIGHT UNIT 28 & 29 2ND FLOOR

GENERAL NOTES

OWNER

Housing Authority of New Haven

HOUSING AUTHORITY OF NEW HAVEN 360 ORANGE STREET NEW HAVEN, CT

ARCHITECT


CHRISTOPHER WILLIAMS ARCHITECTS, LLC 85 Willow Street New Haven, CT 06511 203 776 0184 www.cwarchitectsllc.com

FOR BIDDING

JULY 22 2024

IMPROVEMENTS

DESCRIPTION

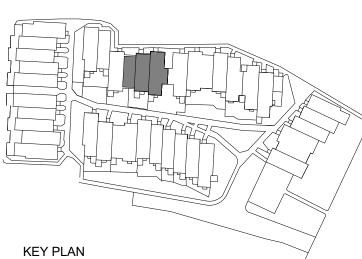

PROJECT NO: CWA PROJECT NO.: 2401

MEP PLAN

MEP 102